

John Wesley Community Church Rehabilitation



40125 Bond Street
Waterford, VA 20197

Waterford Foundation Inc.

40222 Fairfax Street
Waterford, VA 20197
(540) 882-3018
www.waterfordfoundation.org

SMITHGROUP

1700 New York Avenue NW
Suite 100
Washington, DC 20006
(202) 842-2100
www.smithgroup.com

ISSUED FOR:
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DRAWING LIST

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ARCHITECTURAL ABBREVIATIONS

	ANCHOR BOLT		EQUIP	EQUIPMENT		MATL	MATERIAL		RHMS	ROUND HEAD MACHINE		WDW	WINDOW	
	ACP	ACOUSTICAL CEILING PANEL		EQUIV	EQUIVALENT		MATV	MASTER ANTENNA TELEVISION SYSTEM		RHWS	ROUND HEAD WOOD SCREW		WF	WINDOW FILM
	ACS PNL	ACCESS PANEL		ER	EPOXY RESIN		MAX	MAXIMUM		RM	ROOM		WGL	WIRE GLASS
	ACT	ACOUSTICAL CEILING TILE		ESCAL	ESCALATOR		MB	MACHINE BOLT		RND	ROUND		WH	WHITEBOARD
	AD	AREA DRAIN		EST	ESTIMATE(D)		MC	MEDICINE CABINET		RO	ROUGH OPENING		WM	WIRE MESH
	ADDL	ADDITIONAL		ETR	EXISTING TO REMAIN		MDO	MEDIUM DENSITY OVERLAY		ROW	RIGHT OF WAY		WO	WHERE OCCURS
	ADH	ADHESIVE		EWG	ELECTRIC WATER COOLER		MECH	MECHANICAL		RS	RESINOUS FLOOR		WOM	WALK OFF MAT
	ADJ	ADJUSTABLE		EXC	EXCAVATED		MED	MEDIUM		RSN	RESIN PANEL		WP	WALL PROTECTION
	ADJ	ADJACENT		EXH	EXHAUST		MEMB	MEMBRANE		RWL	RAIN WATER LEADER		WPT	WORKING POINT
	AFF	ABOVE FINISH FLOOR		EXP	EXPANSION		MFR	MANUFACTURER	S	S	SOUTH		WR	WATER RESISTANT
	AFG	ABOVE FINISH GRADE		EXP JT	EXPANSION JOINT		MH	MANHOLD		SA	SUPPLY AIR		WSCT	WAINSCOT
	AFS	ABOVE FINISH SLAB		EXT	EXTERIOR		MICRO	MICROWAVE		SB	SPLASH BLOCK		WSP	WET STANDPIPE
	AGGR	AGGREGATE	F	F/F	FACE TO FACE		MIN	MINIMUM		SC	SOLID CORE		WT	WEIGHT
	ALT	ALTERNATE		FA	FIRE ALARM		MISC	MISCELLANEOUS		SCHED	SCHEDULE		WTHPRF	WEATHERPROOF
	ALUM	ALUMINUM		FACP	FIRE ALARM CONTROL PANEL		MKB	MARKERBOARD		SCRN	SCREEN		WTR	WINDOW TREATMENT
	ANOD	ANODIZED		FAS	FIRE SLARM STATION		MLDG	MOLDING		SD	STORM DRAIN		WTRPRF	WATERPROOF
	APPROX	APPROXIMATE(LY)		FB	FLAT BAR		MM	MILLIMETERS		SE	SOUTHEAST		WWF	WELED WIRE FABRIC
	ARCH	ARCHITECT(URAL)		FCU	FAN COIL UNIT		MO	MASONRY OPENING		SECT	SECTION		WWM	WELED WIRE MESH
	AS	ADJUSTABLE SHELF		FD	FLOOR DRAIN		MOD	MODULE, MODULAR		SEG	SEGMENT	X	XFM	TRANSFORMER
	ASPH	ASPHALT		FDC	FIRE DEPARTMENT CONNECTION		MTD	MOUNTED		SEP	SEPARATION OR SEPARATE	Y	YD	YARD
	AVG	AVERAGE		FDN	FOUNDATION		MTG	MOUNTING		SEP JT	SEPARATION JOINT			
	AWF	ACOUSTICAL WALL FABRIC		FE	FIRE EXTINGUISHER		MTL	METAL		SHT	SHEET, SHEETING			
	AWP	ACOUSTICAL WALL PANEL		FEC	FIRE EXTINGUISHER CABINET		MTLB	METAL BASE		SHV	SHELVES, SHELVING			
B	B	BASE		FF	FINISH FACE		MULL	MULLION		SHWR	SHOWER			
	BB	BULLETIN BOARD		FF&E	FURNITURE FIXTURES AND EQUIPMENT		MVBL	MOVABLE		SIM	SIMILAR			
	BD	BOARD		FH/FEC	FIRE HOSE/FIRE EXTINGUISHER CABINET	N	NA	NOT APPLICABLE		SK	SINK			
	BFC	BAFFLE CEILING		FHC	FIRE HOSE CABINET		NAT	NATURAL		SKLR	SPRINKLER			
	BITUM	BITUMINOUS		FHMS	FLAT HEAD MACHINE SCREW		NE	NORTHEAST		SMS	SHEET METAL SCREW			
	BLDG	BUILDING		FHWS	FLAT HEAD WOOD SCREW		NIC	NOT IN CONTRACT		SP	SPACE, SPACED, SPACING			
	BM	BENCHMARK		FHY	FIRE HYDRANT		NO	NUMBER		SPC	SPECIALTY APPLICATION			
	BOS	BOTTOM OF STEEL		FLAM	FLAMMABLE		NOM	NOMINAL		SPD	SOAP DISPENSER			
	BOT	BOTTOM		FLASH	FLASHING		NRC	NOISE REDUCTION COEFFICIENT		SPEC	SPECIFICATION			
	BRG	BEARING		FLEX	FLEXIBLE		NTS	NOT TO SCALE		SPKR	SPEAKER			
	BSMT	BASEMENT		FLUOR	FLUORESCENT		NW	NORTHWEST		SQ	SQUARE			
	BTWN	BETWEEN		FO	FACE OF	O	OA	OVERALL		SS	SANITARY SEWER			
	BUR	BUILT UP ROOFING SYSTEM		FRP	FIBERGLASS REINFORCED PLASTIC		OC	ON CENTER		SSK	SERVICE SINK			
C	CAB	CABINET		FSB	FOLDING SHOWER BENCH		OD	OUTSIDE DIAMETER		SSM	SOLID SURFACE MATERIAL			
	CB	CATCH BASIN		FSTNR	FASTNER		OFCI	OWNER FURNISHED- CONTRACTOR INSTALLED		SST	STAINLESS STEEL			
	CCR	CARD CONTROL READER		FT	FOOT, FEET		OFOI	OWNER FURNISHED- OWNER INSTALLED		ST	STREET			
	CCT	CUBICLE CURTAIN TRACK		FTG	FOOTING		OPP	OPPOSITE		STA	STATION			
	CCTV	CLOSED CIRUIT TELEVISION		FURN	FURNITURE		ORD	OVERFLOW ROOF DRAIN		STAG	STAGGERED			
	CEM	CEMENT, CEMENTITIOUS		FXTR	FIXTURE		OVHD	OVERHEAD		STC	SOUND TRANSMISSION COEFFICIENT			
	CER	CERAMIC	G	G	GAS		OZ	OUNCE		STD	STANDARD			
	CFCI	CONTRACTOR FURNISHED CONTRACTOR INSTALLED		GA	GAUGE, GAGE	P	P	PAINT		STL	STEEL			
	CG	CORNER GUARD		GAL	GALLON		PA	PUBLIC ADDRESS		STN	STONE			
	CI	CAST IRON		GALV	GALVANIZED		PART	PARTIAL		STNB	STONE BASE			
	CJ	CONTROL JOINT		GB	GRAB BAR		PBD	PARTICLEBOARD		STOR	STORAGE			
	CL	CENTER LINE		GC	GENERAL CONTRACTOR		PBX	PRIVATE TELEPHONE EXCHANGE		STRUCT	STRUCTURAL			
	CLG	CEILING		GFRG	GLASS FIBER REINFORCED CONCRETE		PC	PRIVACY CURTAIN		STS	SELF-TAPPING STEEL			
	CLR	CLEAR		GFRG	GLASS FIBER REINFORCED GYPSUM		PCF	POUNDS PER CUBIC FOOT		SUSP	SUPSENDED			
	CMU	CONCRETE MASONRY		GL	GLASS		PCI	POUNDS PER CUBIC INCH		SVCE	SERVICE			
	CNTR	COUNTER		GLU LAM	GLUE LAMINATED		PERF	PERFORATED		SW	SOUTHWEST			
	COL	COLUMN		GLZ	GLAZING		PERIM	PERIMETER		SYMM	SYMMETRICAL			
	CONC	CONCRETE		GR	GRADE OR GRADING		PERM	PERMANENT		SYST	SYSTEM			
	CONF	CONFERENCE		GVL	GRAVEL		PERP	PERPENDICULAR	T	T	TREAD			
	CONN	CONNECTION		GYP	GYPSUM		PI	POINT OF INTERSECTION		T&B	TOP AND BOTTOM			
	CONSTR	CONSTRUCTION		GYP BD	GYPSUM BOARD		PL	PLATE		T&G	TONGUE AND GROOVE			
	CONT	CONTINUOUS		GYP PLAS	GYPSUM PLASTER		PLAM	PLASTIC LAMINATE		TBD	TO BE DETERMINED			
	CONTR	CONTRACTOR		H	HIGH		PLAS	PLASTER		TC	TOP OF CONCRETE, TOP OF CURB			
	CORR	CORRUGATED	H	HB	HOSE BIBB		PLBG	PLUMBING		TD	TRENCH DRAIN			
	CPT	CARPET		HC	HOLLOW CORE		PLF	POUNDS PER LINEAR FOOT		TEL	TELEPHONE			
	CRK	CORK		HD	HEAD		PLYWD	PLYWOOD		TEMP	TEMPORARY			
	CSK	COUNTERSUNK		HDBD	HARDBOARD		PNEU	PENUMATIC		THERM	THERMAL			
	CSP	COMBINATION STANDPIPE		HDW	HARDWARE		PNL	PANEL		THK	THICK, THICKNESS			
	CSWK	CASEWORK		HDWD	HARDWOOD		PNL BD	PANEL BOARD		THRES	THRESHOLD			
D	CU	CUBIC		HGT	HEIGHT		PORT	PORTABLE		THRU	THROUGH			
	D	DEPTH		HMI	HOLLOW METAL		PP	PUSH PLATE		TL	TILE			
	DBL	DOUBLE		HNDRL	HANDRAIL		PPM	PARTS PER MILLION		TLB	TILE BASE			
	DBL ACT	DOUBLE ACTING		HORIZ	HORIZONTAL		PPR	PAPER DISPENSER		TMPO GL	TEMPERED GLASS			
	DEG	DEGREE		HPC	HIGH PERFORMANCE COATING		PR	PAIR		TO	TOP OF			
	DEMO	DEMOLISH		HPD	HEALTH PRODUCT DECLARATION		PRCST	PRECAST		TOR	TOP OF RAILING			
	DEPT	DEPARTMENT		HPT	HIGH POINT		PREFAB	PREFABRICATION		TOS	TOP OF STEEL			
	DET	DETAIL		HR	HOUR		PREFIN	PREFINISHED		TOT	TOTAL			
	DF	DRINKING FOUNTAIN		HVAC	HEATING-VENTILATION-AIR CONDITIONING		PREP	PREPARATION		TOW	TOP OF WALL			
	DIA	DIAMETER	I	ICE	ICE MACHINE		PRKG	PARKING		TP	TOP OF PAVEMENT			
	DIAG	DIAGONAL		ID	INSIDE DIAMETER		PROJ	PROJECT		TPT	TOILET PARTITION			
	DIFF	DIFFUSER		IN	INCH		PROP	PROPERTY		TRC	TRASH RECEPTACLE			
	DIM	DIMENSION		INCAND	INCANDESCENT		PSF	POUNDS PER SQUARE FOOT		TRZ	TERAZZO			
	DIM PT	DIMENSION POINT		INCL	INCLUDE, INCLUDING		PSI	POUNDS PER SQUARE INCH		TTB	TELEPHONE TERMINAL BOARD			
	DISP	DISPENSER		INFO	INFORMATION		PT	POINT		TV	TELEVISION			
	DIST	DISTANCE		INSUL	INSULATION		PTN	PARTITION		TYP	TYPICAL			
	DN	DOWN		INTR	INTERIOR		PTX	PNEUMATIC TUBE STATION		U	UC UNDER COUNTER			
	DR	DRAIN		INV	INVERT		PVC	POLYVINYL CHLORIDE		UL	UNDERWRITER'S LABORATORIES			
	DS	DOWNSPOUT		IVT	INTRAVENOUS TRACK		PVG	PAVING		UON	UNLESS OTHERWISE NOTED			
	DSP	DRY STANDPIPE	J	JAN	JANITOR		PVMT	PAVEMENT		UPH	UPHOLSTERY			
	DW	DISHWASHER		JST	JOIST		PWR	POWER		UPS	UNINTERRUPTABLE POWER SUPPLY			
	DWG	DRAWING		JT	JOINT	Q	QTR	QUARTER		UTIL	UTILITY			
	DWGS	DRAWINGS		K	KG KILOGRAM		QTY	QUANTITY		V	VAC VACUUM			
E	(E)	EXISTING		KIT	KITCHEN	R	R	RISER		VB	VALVE BOX			
	EA	EACH		KPL	KICK PLATE		R/O	REVERSE OSMOSIS WATER		VCT	VINYL COMPOSITION TILE			
	EDR	EQUIPMENT DRAWING		KS	KNEE SPACE		RA	RETURN AIR		VERT	VERTICAL			
	EG	EDGE GUARD	L	L	LENGTH, LONG		RAD	RADIUS		VEST	VESTIBULE			
	EIFS	EXTERIOR INSULATION FINISH SYSTEM		LAB	LABORATORY		RB	RESILIENT BASE		VIF	VERIFY IN FIELD			
	EL	ELEVATION		LAM	LAMINATE, LAMINATION		RCP	REFLECTED CEILING PLAN		VIT	VITREOUS			
	ELAST	ELASTOMERIC		LAV	LAVATORY		RCPT	RECEPTACLE		VOL	VOLUME			
	ELEC	ELECTRICAL		LB	POUND		RD	ROOF DRAIN		VP	VENT PIPE			
	ELEV	ELEVATOR		LED	LIGHT EMITTING DIODE		RE	REFERENCE	W	W	WEST			
	EMER	EMERGENCY		LF	LINEAR FOOT		RECT	RECTANGULAR	W	W	WITH			
	ENCL	ENCLOSURE		LG	LENGTH		REF	REFRIGERATOR		WD	WASHER/DRYER			
	ENGR	ENGINEER		LIN	LINEAR		REG	REGISTER		W/O	WITHOUT			
	EOS	EDGE OF SLAB		LL	LEAD LINED		REINF	REINFORCE (D) (ING) (MENT)		WW	WALL TO WALL			
	EP	ELECTRICAL PANEL		LPT	LOW POINT		REQD	REQUIRED		WC	WATER CLOSET			
	EPB	ELECTRICAL PANEL BOARD		LT	LIGHT		REQT	REQUIREMENT		WCHR	WHEELCHAIR			
	EPD	ENVIRONMENTAL PRODUCT DECLARATION		LT WT	LIGHT WEIGHT		RET	RETURN AIR		WCV	WALLCOVERING			
	EPDM	ETHYLENE PROPYLENE DIENE MONOMER		LTG	LIGHTING		REV	REVISION		WD	WOOD			
	EPX	EPOXY		LVR	LOUVER		RF	RESILIENT FLOORING		WDB	WOOD BASE			
	EQ	EQUAL	M	M	METERS		RH	RIGHT HAND		WDF	WOOD FLOORING			
	EQL SO	EQUALLY SPACED		MACH	MACHINE					WDV	WOOD VENEER			

ARCHITECTURAL GENERAL NOTES

THE FOLLOWING GENERAL NOTES APPLY TO ALL ARCHITECTURAL SERIES SHEETS. FOR GENERAL NOTES APPLICABLE TO ALL SHEETS REFER TO THE 'PROJECT GENERAL NOTES'.

A. THE ARCHITECTURAL SERIES SHEETS ARE PART OF A COMPLETE SET OF CONSTRUCTION DOCUMENTS DESCRIBING THE WORK FOR THIS PROJECT. USERS OF THESE DOCUMENTS ARE RESPONSIBLE TO REVIEW ALL CONSTRUCTION DOCUMENTS TO UNDERSTAND AND COORDINATE THE GRAPHIC AND ANNOTATED INFORMATION PROVIDED IN THESE ARCHITECTURAL SERIES SHEETS.

B. EXCEPT WHERE DIRECTED TO PLACE ITEMS OF WORK AT THE APPROXIMATE LOCATIONS SHOWN, DO NOT SCALE DRAWINGS FOR DIMENSIONAL INFORMATION. ALL ELEMENTS OF THE DRAWINGS MAY NOT BE DRAWN TO EXACT SCALE. ALL DIMENSIONS REQUIRED ARE SHOWN OR MAY BE DERIVED FROM THOSE SHOWN ON THE FLOOR PLANS, DETAIL PLANS, ELEVATIONS, SECTIONS, DETAILS, SCHEDULES, AND SPECIFICATIONS.

C. ALL VISUALLY EXPOSED STRUCTURAL, MECHANICAL AND ELECTRICAL ELEMENTS, INCLUDING EXPOSED METAL FLOOR AND ROOF DECK, ARE TO BE PAINTED UNLESS OTHERWISE NOTED. THIS INCLUDES ELEMENTS THAT MAY BE VISIBLE THROUGH GRILLES, LOUVERS OR CEILING COLORS AND PAINT MATERIALS ARE DEFINED IN THE FINISH SCHEDULE, THE SPECIFICATIONS, AND THE DRAWINGS AS APPLICABLE TO THE CONSTRUCTION DOCUMENTS.

REFERENCE ELEVATION DEFINITIONS

<p>A. THE TERM "REFERENCE" ELEVATION OR DIMENSIONS REFERS TO A NOMINAL WORK POINT. THE ACTUAL ELEVATION MAY VARY FROM THE REFERENCE POINT. REFER TO APPLICABLE DETAIL TO DETERMINE THE RELATIONSHIP BETWEEN THE ACTUAL ELEVATION OR DIMENSION AND THE STATED REFERENCE POINT."</p>	<p>D. WHERE CONCRETE FLOOR SLAB IS DERESSED TO ACCOMMODATE MORTAR BEDS, SETTING BEDS, RAISED ACCESS FLOORS, AND OTHER SIMILAR FLOOR ASSEMBLIES, "FINISHED FLOOR" ELEVATIONS ARE MEASURED AS IF CONCRETE DEPRESSION DOES NOT OCCUR.</p>
<p>B. THE DESIGN REFERENCE ELEVATION "-0'-0" SHOWN ON THE ARCHITECTURAL DRAWINGS CORRESPONDS TO THE FINISH FLOOR ELEVATION OF THE GROUND FLOOR. ESTABLISH THE ACTUAL ELEVATION WITH RESPECT TO SITE-SPECIFIC BENCHMARKS AND CONTROL POINTS AS DEFINED IN THE CIVIL DRAWINGS.</p>	<p>E. CEILING HEIGHT ELEVATIONS ARE MEASURED TO BOTTOM OF FINISH SURFACES AND STATED IN RELATION TO DISTANCE ABOVE THE REFERENCE ELEVATION FOR THE FINISH FLOOR UNLESS OTHERWISE NOTED.</p>
<p>C. "FINISH FLOOR" ELEVATIONS ARE MEASURED AT THE TOP OF THE CONCRETE FLOOR SLAB UNLESS OTHERWISE NOTED. APPLIED FINISHES SUCH AS RESILIENT FLOORING OR CARPET MAY RAISE THE ACTUAL FINISH SURFACE ABOVE THE REFERENCE ELEVATION PROVIDED FOR THE FINISH FLOOR.</p>	<p>F. ROOF ELEVATIONS ARE MEASURED TO TOP OF SURFACES AND STATED IN RELATION TO DISTANCE ABOVE THE REFERENCE ELEVATION. PROVIDED FOR THE UPPERMOST FINISH FLOOR UNLESS OTHERWISE NOTED. ELEVATIONS GIVEN ARE TO TOP OF STEEL (TOS), TOP OF DECK (TOD), OR TOP OF TAPERED INSULATION (TTI) UNLESS OTHERWISE NOTED.</p>

ARCHITECTURAL SYMBOL NOTES

A. THE PURPOSE OF THIS SHEET IS TO ILLUSTRATE AND DEFINE TYPICAL GRAPHIC SYMBOLS WHICH MAY TYPICALLY OCCUR ON THE ARCHITECTURAL DRAWINGS.

B. THIS SHEET MAY ILLUSTRATE ABBREVIATIONS, SYMBOLS AND LEGENDS WHICH DO NOT OCCUR AS PART OF THIS PROJECT. REFER TO THE DRAWINGS TO DETERMINE WHICH ITEMS APPLY TO THE WORK OF THIS PROJECT.

C. ADDITIONAL SYMBOLS NOT SHOWN OR DEFINED ON THIS SHEET MAY BE USED ON THE ARCHITECTURAL DRAWINGS AND ARE TYPICALLY DEFINED ON OTHER SHEETS.

D. SYMBOLS ARE NOT DRAWN TO SCALE. TO DETERMINE THE ACTUAL SIZES OF ELEMENTS REPRESENTED BY SYMBOLS, REFER TO THE SPECIFICATIONS AND OTHER SHEETS, AS MAY APPLY.

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40125 Bond Street
Waterford, VA 20197

SMITHGROUP

ARCHITECTURE/ HISTORIC PRESERVATION
1700 New York Avenue, NW
Suite 100
Washington, DC 20004
202.842.2100

TYLin
STRUCTURAL ENGINEERING
1053 31st Street NW
Washington, DC 20007
202.333.6230

[illegible]

SEALS AND SIGNATURES

NOT FOR
CONSTRUCTION


SHEET TITLE

ARCHITECTURAL ABBREVIATIONS AND SYMBOLS

PROJECT NUMBER	15362.000
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A0.1

SHEET NUMBER

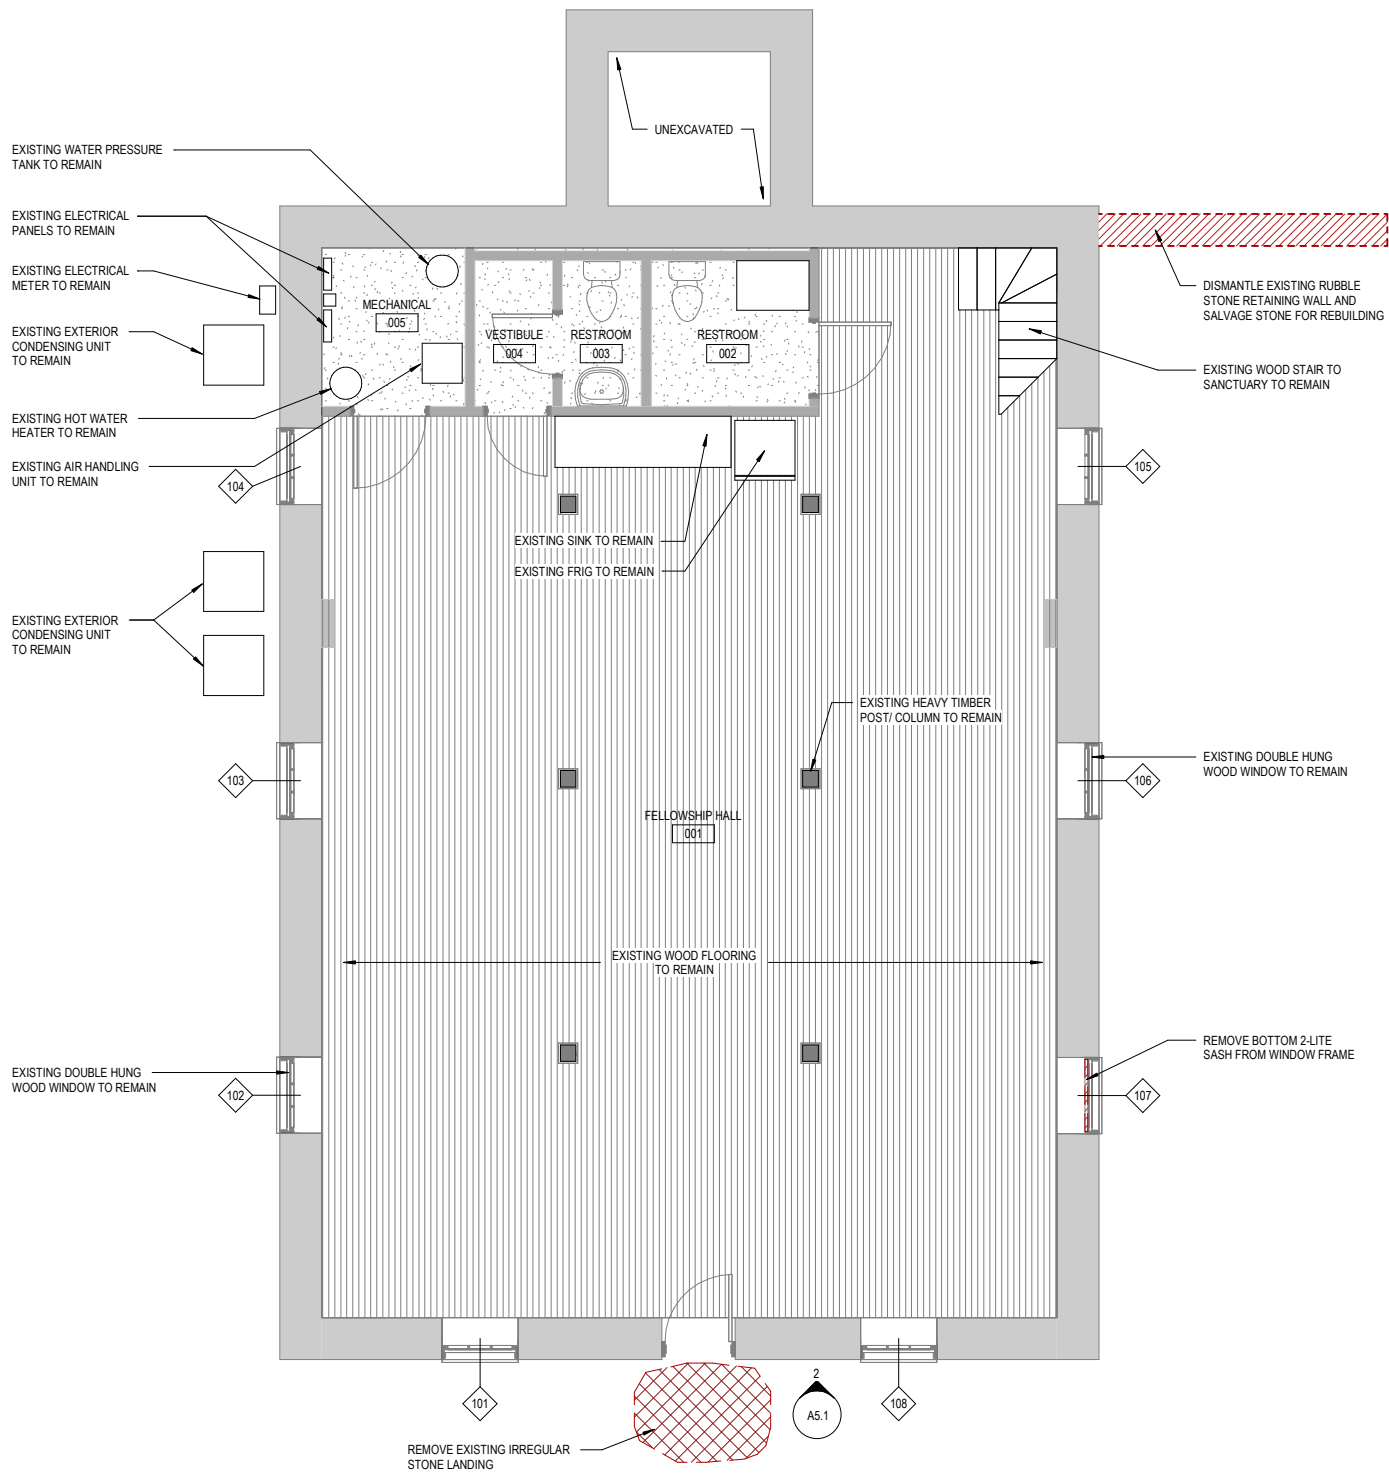

1 BASEMENT DEMOLITION FLOOR PLAN
SCALE: 1/4" = 1'-0"

GENERAL SHEET NOTES

- A. REFER TO THE PROJECT GENERAL NOTES IN THE G1.X SERIES FOR INFORMATION REGARDING VERIFICATION AND PROTECTION OF EXISTING CONDITIONS.
- B. REFER TO THE A0.X SERIES SHEETS FOR ARCHITECTURAL GENERAL NOTES, DRAWING, REFERENCE AND MATERIAL SYMBOLS, ABBREVIATIONS, AS WELL AS DIMENSIONING CONVENTIONS USED ON THIS DRAWING.
- C. DEMOLITION WORK SHALL BE DONE IN A MANNER WHICH WILL NOT CAUSE UNNECESSARY INCONVENIENCE OR DANGER TO USERS OF THE PREMISES AND ADJACENT SITE AND NOT INTERFERE WITH ITS OPERATION. ANY DEMOLITION WORK TO BE PERFORMED MUST BE PLANNED IN ADVANCE AND APPROVED BY THE OWNER.
- D. ALL MATERIALS INDICATED TO BE REMOVED SHALL BE DISPOSED OF PROPERLY AND REMOVED FROM THE SITE.
- E. ALL REMOVED MATERIALS AND EQUIPMENT WHICH IS CLASSIFIED AS "SALVAGE FOR OWNER" SHALL REMAIN THE PROPERTY OF THE OWNER. DELIVER SUCH MATERIALS AND EQUIPMENT ON THE PREMISES AS DIRECTED BY THE OWNER AND NEATLY STORE AND PROTECT FROM DAMAGE. ALL EXISTING LIGHT FIXTURES TO BE REMOVED SHOULD BE RETURNED TO THE OWNER.
- F. ALL REMOVED MATERIALS AND EQUIPMENT WHICH IS CLASSIFIED "SALVAGE FOR RELOCATION" SHALL REMAIN THE PROPERTY OF THE OWNER. THE CONTRACTOR IS RESPONSIBLE FOR PLACING ITEMS IN STORAGE ON SITE AND FOR THE PROTECTION OF THOSE ITEMS. THESE ITEMS WILL BE RELOCATED. REFER TO THE FLOOR PLANS FOR NEW LOCATIONS.
- G. PATCH AND REPAIR ALL ELEMENTS THAT ARE TO REMAIN WHICH ARE DAMAGED FROM THE DEMOLITION WORK WITH CONSTRUCTION TO MATCH EXISTING CONDITIONS.

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ARCHITECTURE/ HISTORIC PRESERVATION
1700 New York Avenue, NW
Suite 100
Washington, DC 20004
202.842.2100

TYLin
STRUCTURAL ENGINEERING
1053 31st Street NW
Washington, DC 20007
202.333.6230

ISSUED FOR	DATE

SEALS AND SIGNATURES

NOT FOR
CONSTRUCTION

KEYPLAN

NORTH



SHEET TITLE


BASEMENT DEMOLITION
FLOOR PLAN

PROJECT NUMBER

15362.000

SHEET NUMBER

AD2.0

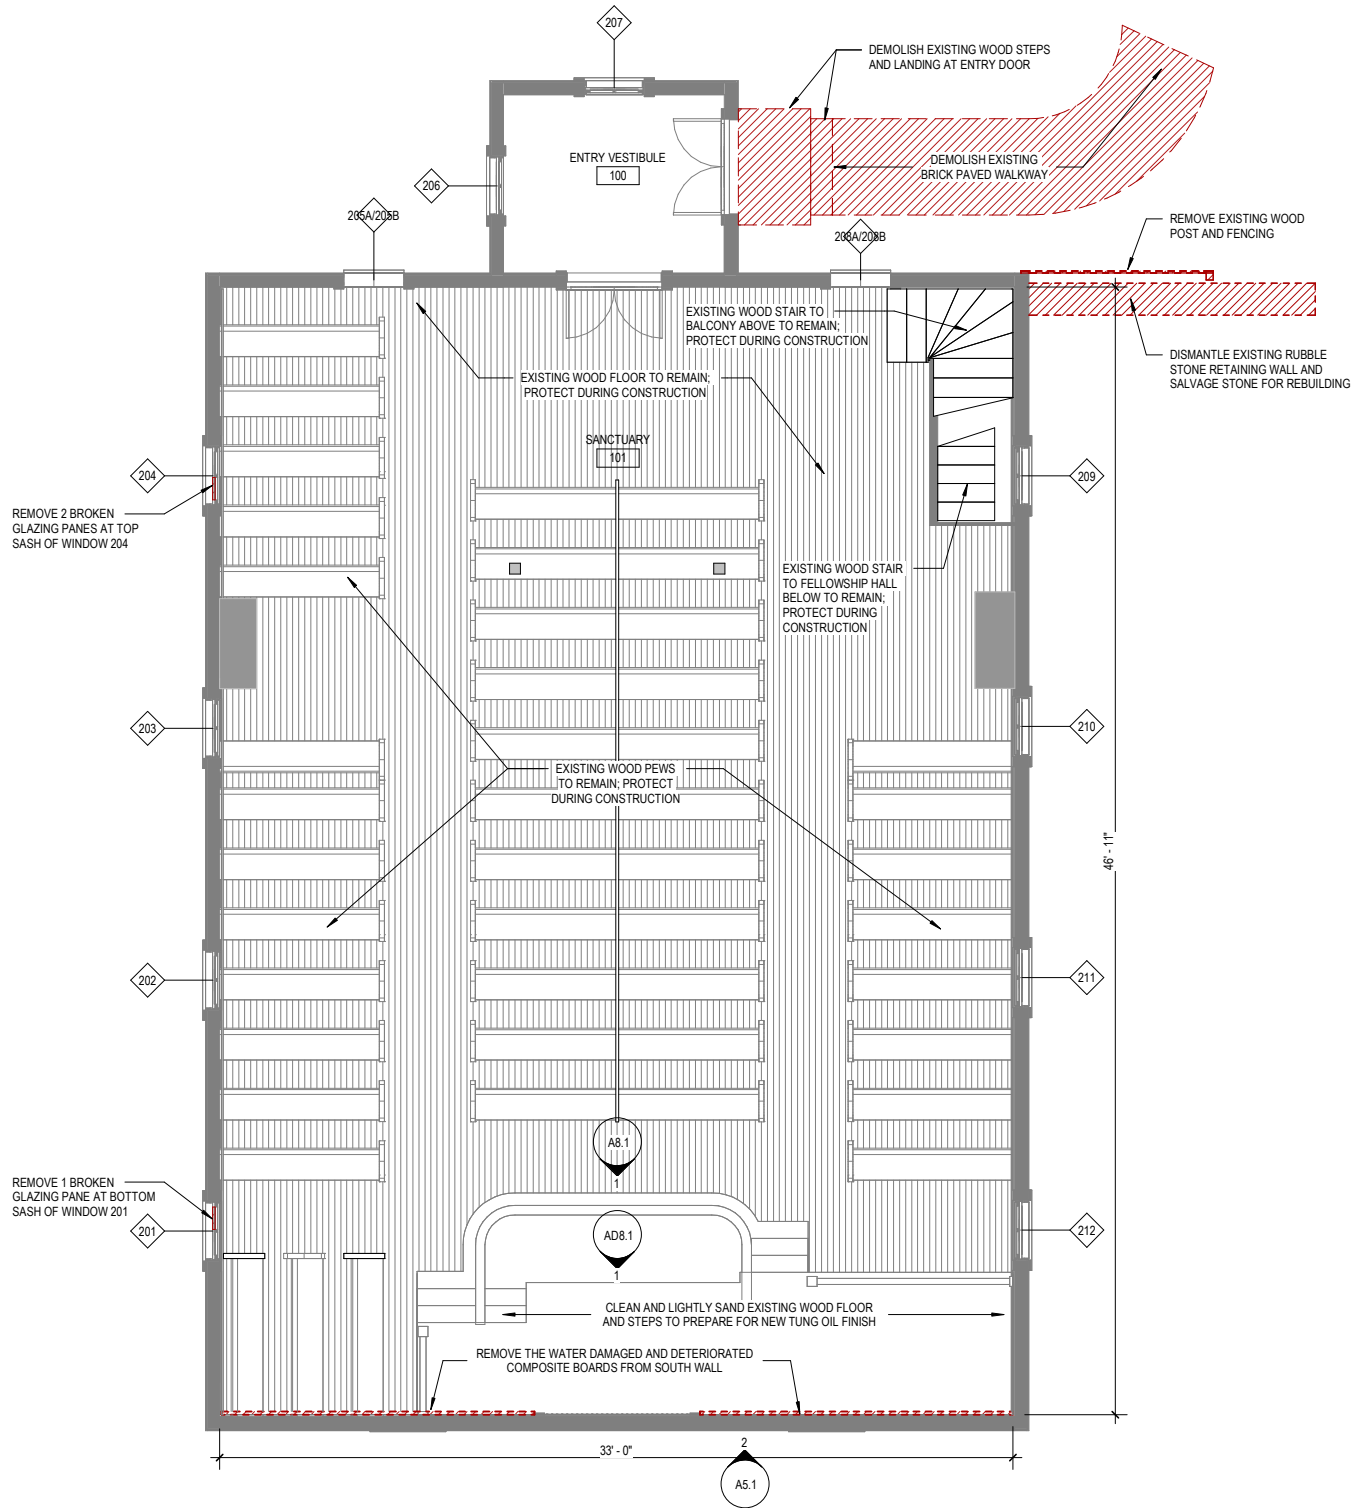

1 SANCTUARY DEMOLITION FLOOR PLAN
SCALE: 1/4" = 1'-0"

GENERAL SHEET NOTES

- REFER TO THE PROJECT GENERAL NOTES IN THE G1.X SERIES FOR INFORMATION REGARDING VERIFICATION AND PROTECTION OF EXISTING CONDITIONS.
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- DEMOLITION WORK SHALL BE DONE IN A MANNER WHICH WILL NOT CAUSE UNNECESSARY INCONVENIENCE OR DANGER TO USERS OF THE PREMISES AND ADJACENT SITE AND NOT INTERFERE WITH ITS OPERATION. ANY DEMOLITION WORK TO BE PERFORMED MUST BE PLANNED IN ADVANCE AND APPROVED BY THE OWNER.
- ALL MATERIALS INDICATED TO BE REMOVED SHALL BE DISPOSED OF PROPERLY AND REMOVED FROM THE SITE.
- ALL REMOVED MATERIALS AND EQUIPMENT WHICH IS CLASSIFIED AS "SALVAGE FOR OWNER" SHALL REMAIN THE PROPERTY OF THE OWNER. DELIVER SUCH MATERIALS AND EQUIPMENT ON THE PREMISES AS DIRECTED BY THE OWNER AND NEATLY STORE AND PROTECT FROM DAMAGE. ALL EXISTING LIGHT FIXTURES TO BE REMOVED SHOULD BE RETURNED TO THE OWNER.
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- PATCH AND REPAIR ALL ELEMENTS THAT ARE TO REMAIN WHICH ARE DAMAGED FROM THE DEMOLITION WORK WITH CONSTRUCTION TO MATCH EXISTING CONDITIONS.

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ARCHITECTURE/ HISTORIC PRESERVATION
1700 New York Avenue, NW
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TYLin
STRUCTURAL ENGINEERING
1053 31st Street NW
Washington, DC 20007
202.333.6230

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SEALS AND SIGNATURES

NOT FOR
CONSTRUCTION

KEYPLAN

NORTH



SHEET TITLE

SANCTUARY
DEMOLITION FLOOR
PLAN

PROJECT NUMBER

15362.000

SHEET NUMBER

AD2.1

A. REFER TO THE PROJECT GENERAL NOTES IN THE G1-X SERIES FOR INFORMATION REGARDING VERIFICATION AND PROTECTION OF EXISTING CONDITIONS.

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D. ALL MATERIALS INDICATED TO BE REMOVED SHALL BE DISPOSED OF PROPERLY AND REMOVED FROM THE SITE.

F. ALL REMOVED MATERIALS AND EQUIPMENT WHICH IS CLASSIFIED AS "SALVAGE FOR OWNER" SHALL REMAIN THE PROPERTY OF THE OWNER. DELIVER SUCH MATERIALS AND EQUIPMENT ON THE PREMISES AS DIRECTED BY THE OWNER AND NEATLY STORE AND PROTECT FROM DAMAGE.

ALL EXISTING LIGHT FIXTURES TO BE REMOVED SHOULD BE RETURNED TO THE OWNER.

F. ALL REMOVED MATERIALS AND EQUIPMENT WHICH IS CLASSIFIED "SALVAGE FOR RELOCATION" SHALL REMAIN THE PROPERTY OF THE OWNER. THE CONTRACTOR IS RESPONSIBLE FOR PLACING ITEMS IN STORAGE ON SITE AND FOR THE PROTECTION OF THOSE ITEMS. THESE ITEMS WILL BE RELOCATED. REFER TO THE FLOOR PLANS FOR NEW LOCATIONS.

G. PATCH AND REPAIR ALL ELEMENTS THAT ARE TO REMAIN WHICH ARE DAMAGED FROM THE DEMOLITION WORK WITH CONSTRUCTION TO MATCH EXISTING CONDITIONS.

40125 Bond Street
Waterford, VA 20197

ARCHITECTURE/ HISTORIC PRESERVATION
1700 New York Avenue, NW
Suite 100
Washington, DC 20004
202.842.2100

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SEALS AND SIGNATURES

NOT FOR
CONSTRUCTION

KEYPLAN




SHEET TITLE

SANCTUARY
DEMOLITION REFLECTED
CEILING PLANS

PROJECT NUMBER	15362.000
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AD3.1

SHEET NUMBER

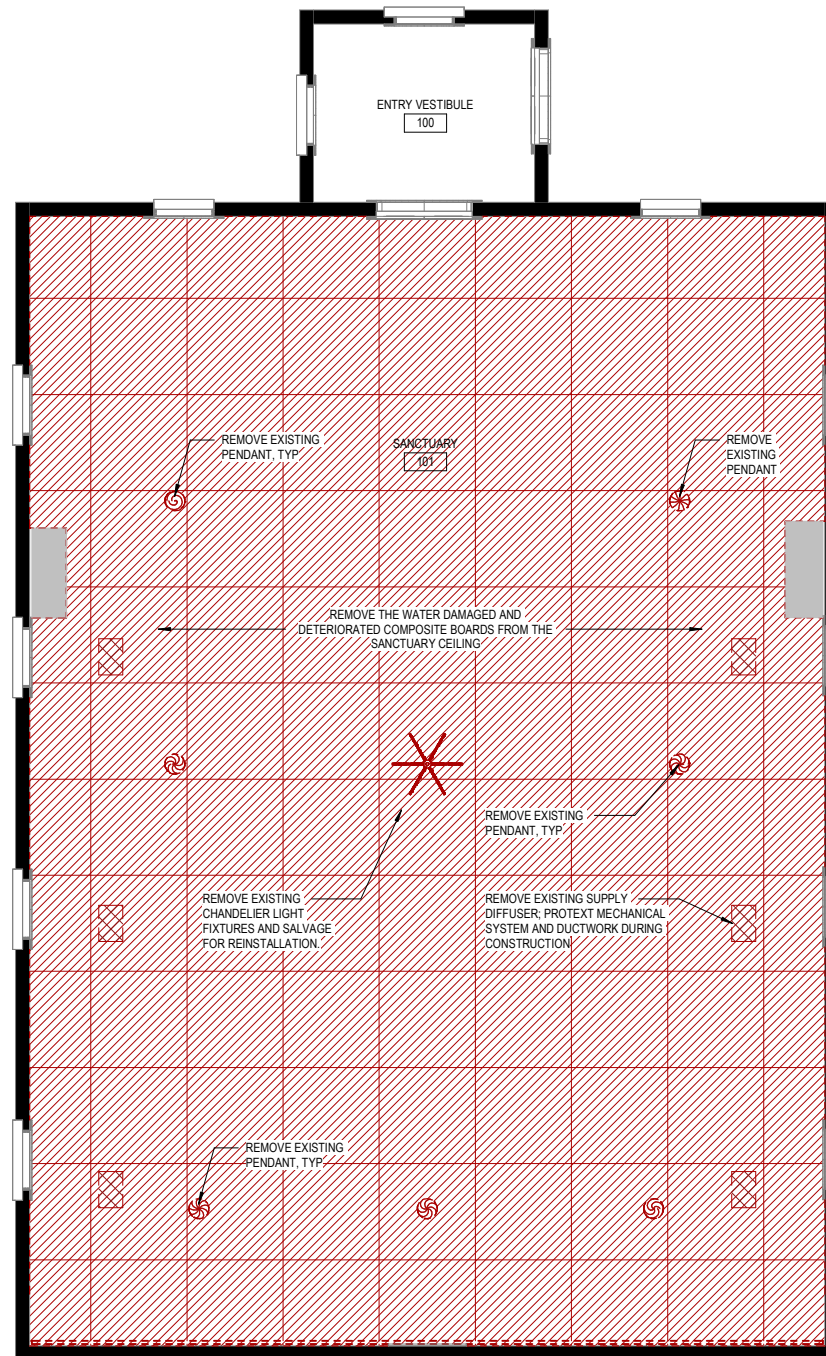

1 SANCTUARY DEMOLITION REF CEILING PLAN
SCALE: 1/4" = 1'-0"

A. REFER TO THE PROJECT GENERAL NOTES IN THE G1-X SERIES FOR INFORMATION REGARDING VERIFICATION AND PROTECTION OF EXISTING CONDITIONS.

B. REFER TO THE A0-X SERIES SHEETS FOR ARCHITECTURAL GENERAL NOTES, DRAWING, REFERENCE AND MATERIAL SYMBOLS, ABBREVIATIONS, AS WELL AS DIMENSIONING CONVENTIONS USED ON THIS DRAWING.

C. DEMOLITION WORK SHALL BE DONE IN A MANNER WHICH WILL NOT CAUSE UNNECESSARY INCONVENIENCE OR DANGER TO USERS OF THE PREMISES AND ADJACENT SITE AND NOT INTERFERE WITH ITS OPERATION. ANY DEMOLITION WORK TO BE PERFORMED MUST BE PLANNED IN ADVANCE AND APPROVED BY THE OWNER.

D. ALL MATERIALS INDICATED TO BE REMOVED SHALL BE DISPOSED OF PROPERLY AND REMOVED FROM THE SITE.

F. ALL REMOVED MATERIALS AND EQUIPMENT WHICH IS CLASSIFIED AS "SALVAGE FOR OWNER" SHALL REMAIN THE PROPERTY OF THE OWNER. DELIVER SUCH MATERIALS AND EQUIPMENT ON THE PREMISES AS DIRECTED BY THE OWNER AND NEATLY STORE AND PROTECT FROM DAMAGE.

ALL EXISTING LIGHT FIXTURES TO BE REMOVED SHOULD BE RETURNED TO THE OWNER.

F. ALL REMOVED MATERIALS AND EQUIPMENT WHICH IS CLASSIFIED "SALVAGE FOR RELOCATION" SHALL REMAIN THE PROPERTY OF THE OWNER. THE CONTRACTOR IS RESPONSIBLE FOR PLACING ITEMS IN STORAGE ON SITE AND FOR THE PROTECTION OF THOSE ITEMS. THESE ITEMS WILL BE RELOCATED. REFER TO THE FLOOR PLANS FOR NEW LOCATIONS.

G. PATCH AND REPAIR ALL ELEMENTS THAT ARE TO REMAIN WHICH ARE DAMAGED FROM THE DEMOLITION WORK WITH CONSTRUCTION TO MATCH EXISTING CONDITIONS.

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Waterford, VA 20197

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Suite 100
Washington, DC 20004
202.842.2100

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SEALS AND SIGNATURES

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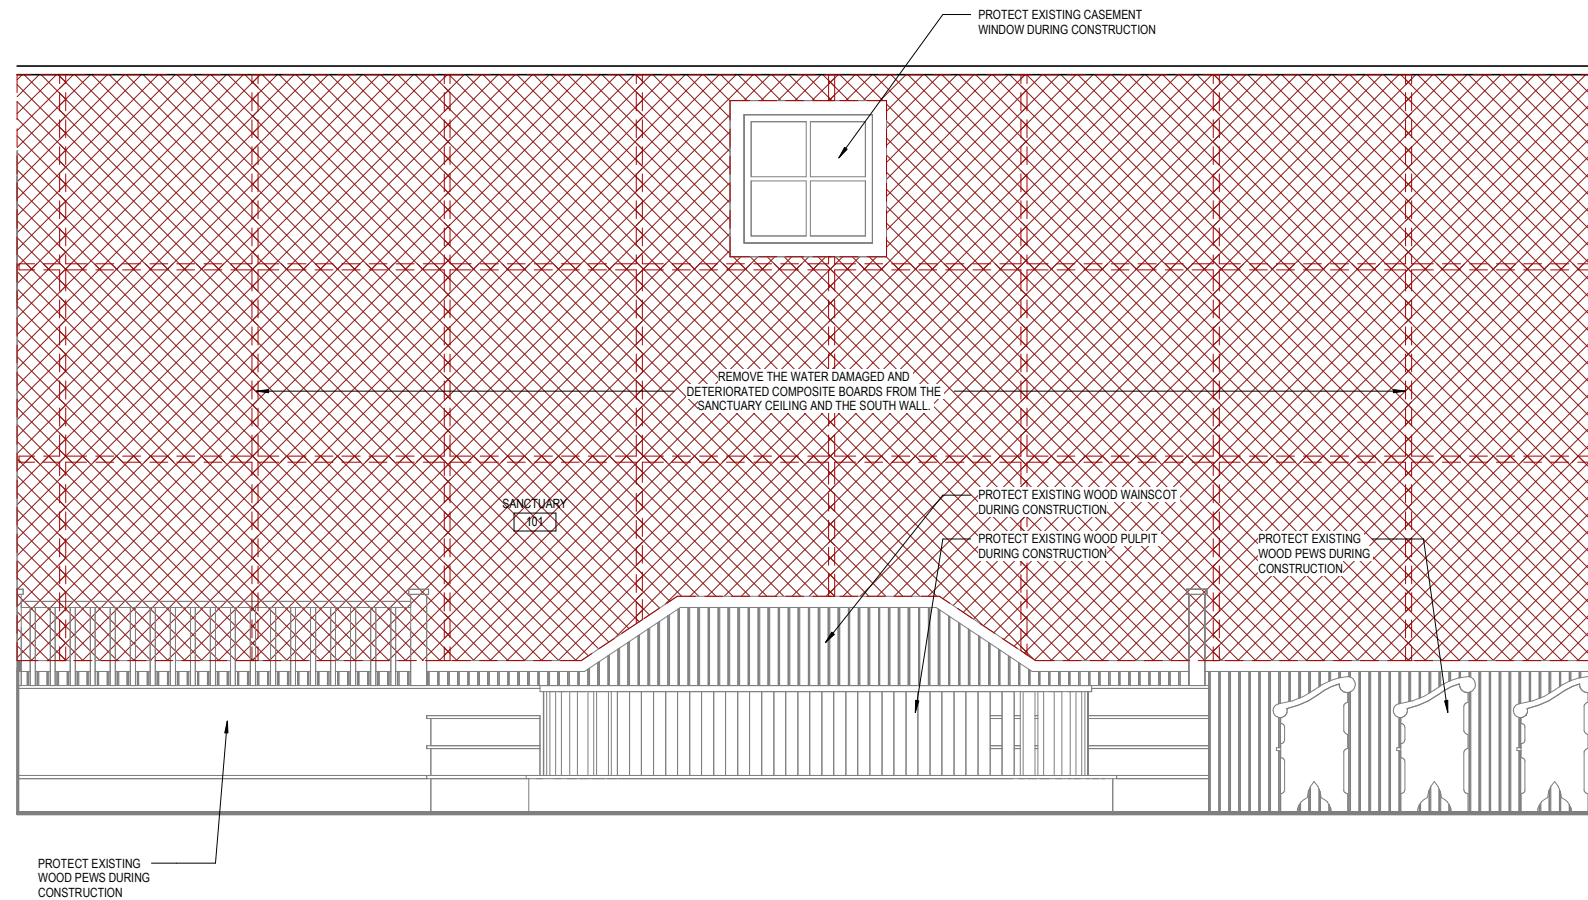
SHEET TITLE

SOUTH INTERIOR
DEMOLITION ELEVATION


PROJECT NUMBER 15362.000

AD8.1

SHEET NUMBER



1 SOUTH INTERIOR DEMOLITION ELEVATION
SCALE: 1/2" = 1'-0"

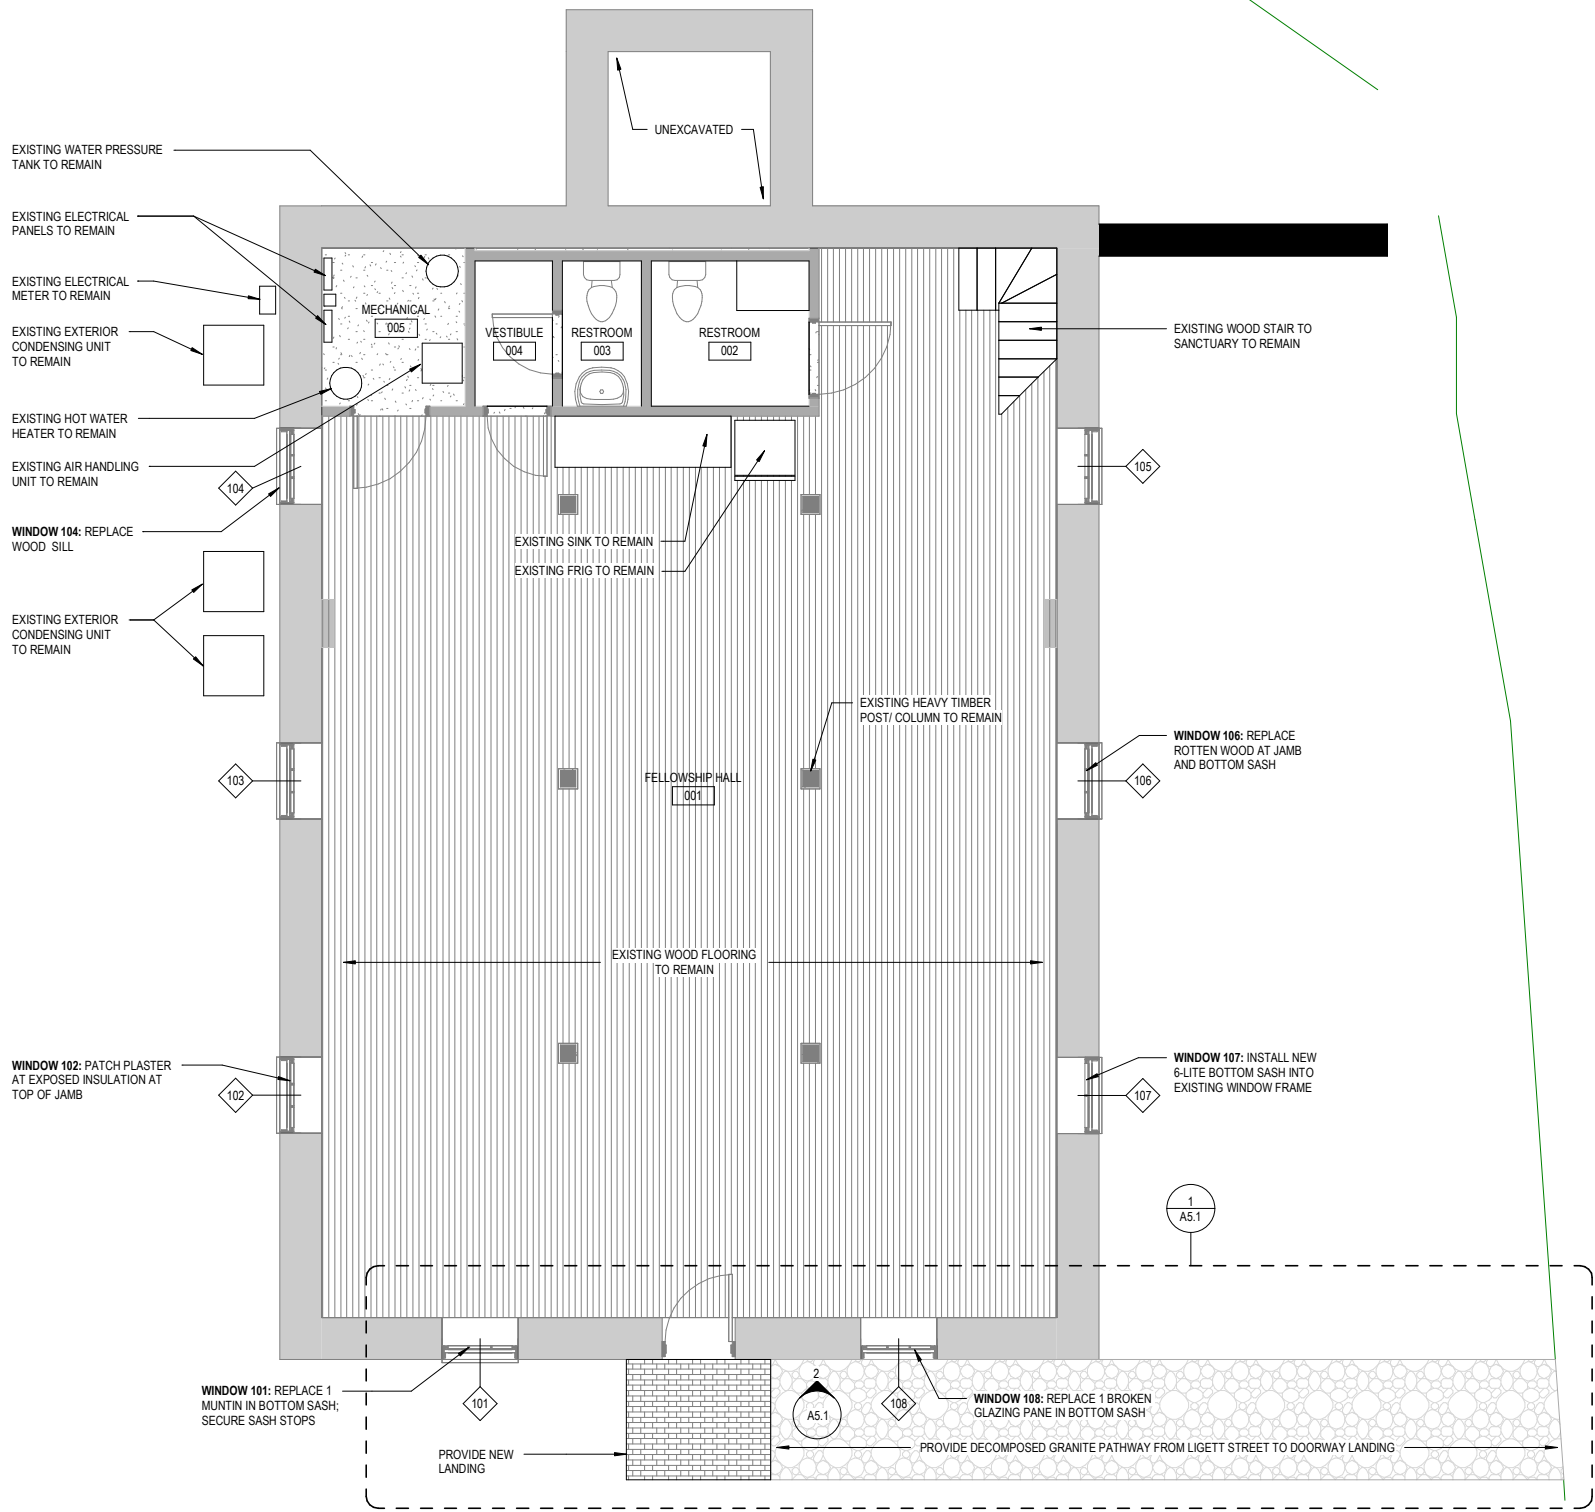

1 BASEMENT FLOOR PLAN
SCALE: 1/4" = 1'-0"

GENERAL SHEET NOTES

- REFER TO THE A0.X SERIES SHEETS FOR ARCHITECTURAL GENERAL NOTES, DRAWING, REFERENCE AND MATERIAL SYMBOLS, ABBREVIATIONS, AS WELL AS DIMENSIONING CONVENTIONS USED ON THIS SHEET.
- ALL DIMENSIONS SHOWN SHALL BE VERIFIED PRIOR TO CONSTRUCTION.
- REFER TO THE A3.X SERIES SHEETS FOR THE REFLECTED CEILING PLANS.
- REFER TO THE A9.2.X SERIES SHEETS FOR PARTITION SYSTEMS TYPES AND DETAILS.

WINDOW RESTORATION

SEE DRAWINGS NOTES RELATED TO SPECIFIC REPAIRS AT EACH WINDOW. THE FOLLOWING NOTES APPLY TO ALL EXISTING WINDOWS WITHIN THE BASEMENT.

- CLEAN, RESTORE, AND REFINISH INTERIOR OF ALL UNPAINTED SASHES, FRAMES, AND SILLS WITH A SOLUTION CONSISTING OF 60% BOILED LINSEED OIL AND 40% TURPENTINE.
- REMOVE REMAINING OVER PAINT ON EXTERIOR OF GLAZING.
- ADJUST EXISTING SASHES TO SECURELY FIT WITHIN EXISTING FRAMES WITHOUT GAPS.
- INSTALL WEATHERSTRIPPING BETWEEN SASHES AND FRAMES.
- PROVIDE INTERIOR LOCKING HARDWARE TO SECURE SASHES.

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40125 Bond Street
Waterford, VA 20197

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ARCHITECTURE/ HISTORIC PRESERVATION
1700 New York Avenue, NW
Suite 100
Washington, DC 20004
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SEALS AND SIGNATURES

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KEYPLAN

NORTH



SHEET TITLE


BASEMENT FLOOR PLAN

PROJECT NUMBER

15362.000

SHEET NUMBER

A2.0

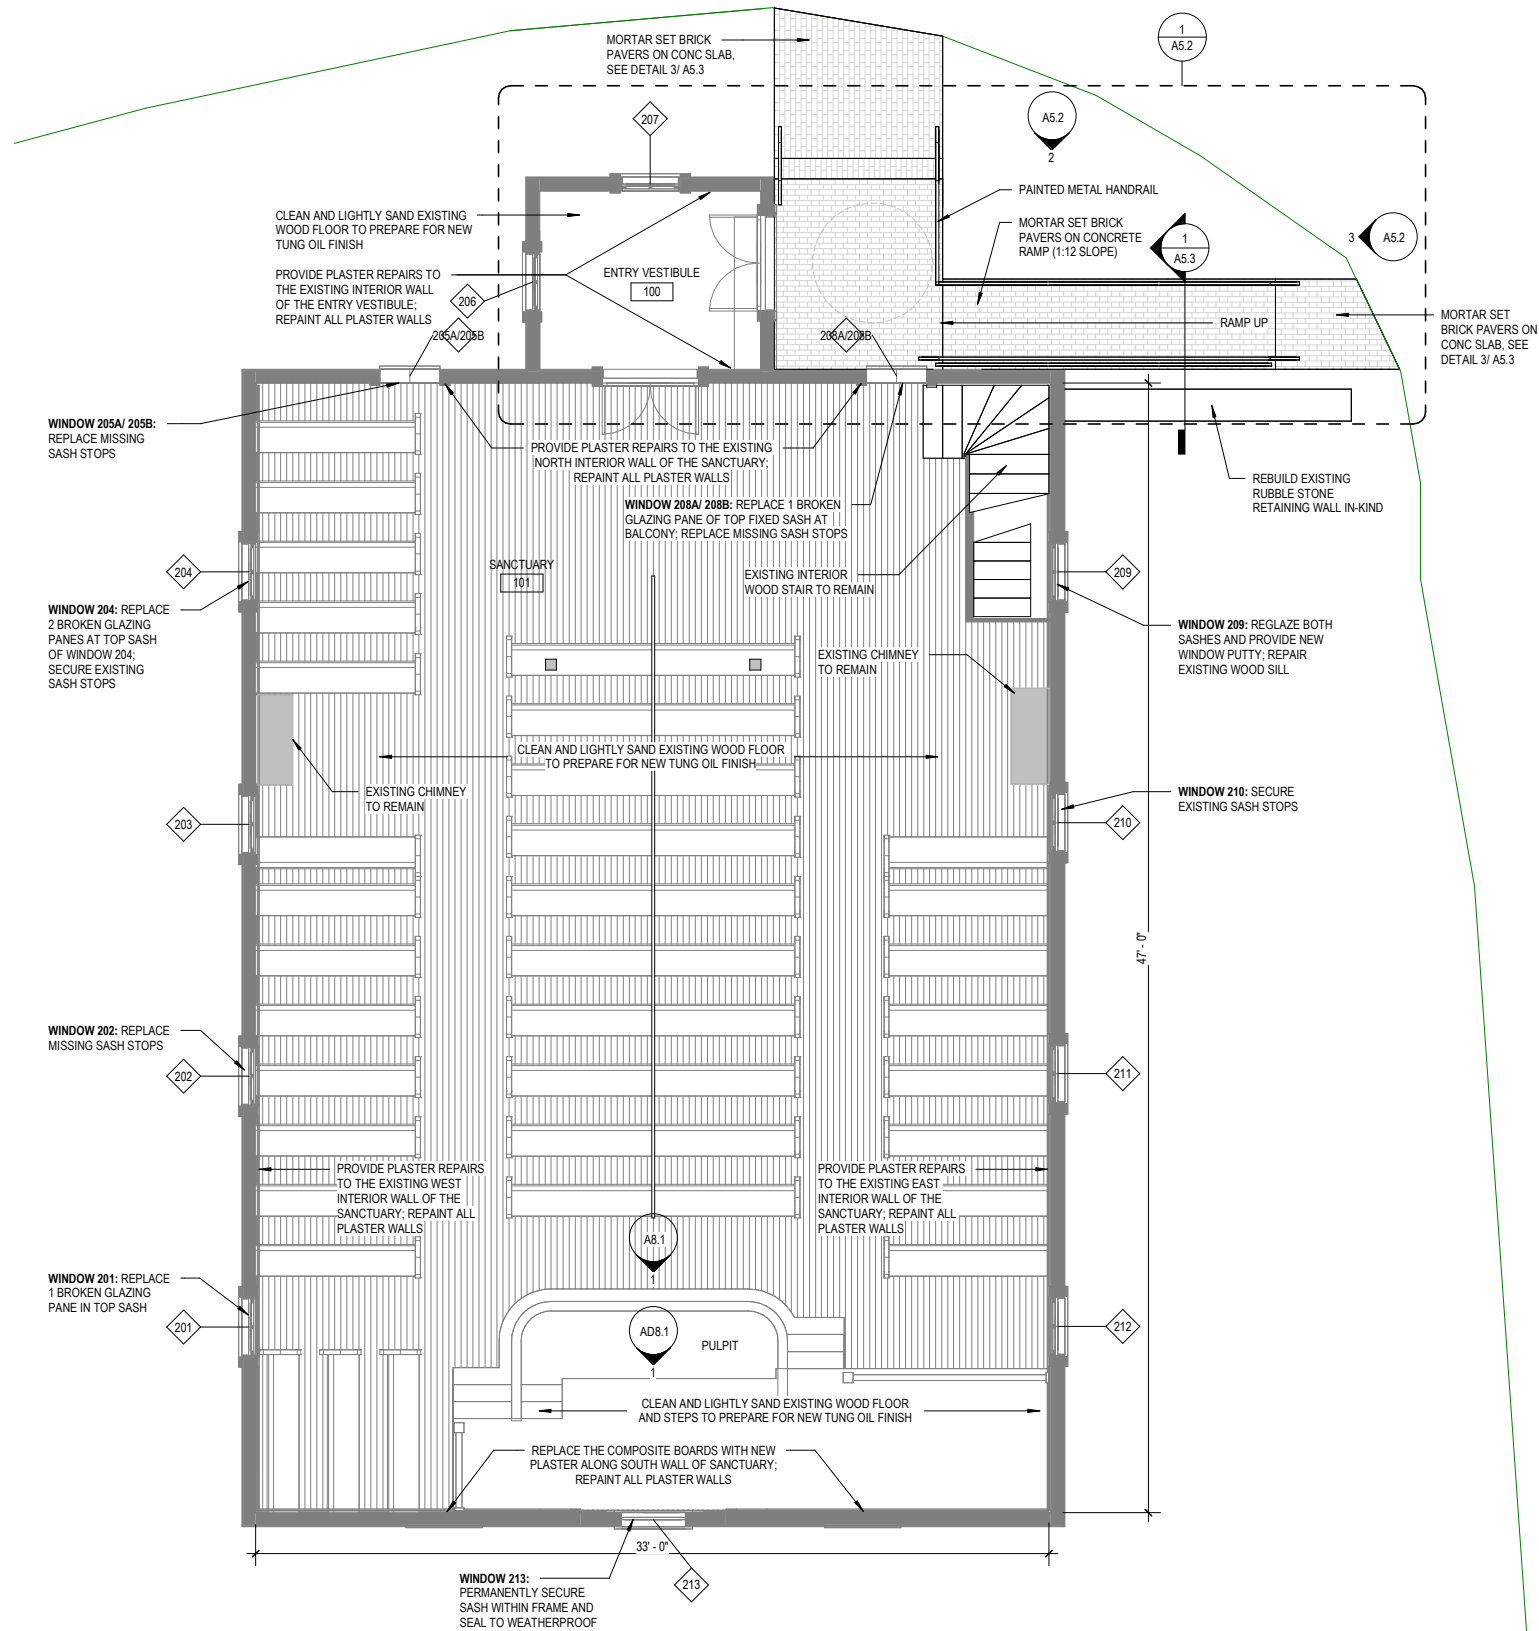

1 SANCTUARY FLOOR PLAN
SCALE: 1/4" = 1'-0"

GENERAL SHEET NOTES

- A. REFER TO THE A0.X SERIES SHEETS FOR ARCHITECTURAL GENERAL NOTES, DRAWING, REFERENCE AND MATERIAL SYMBOLS, ABBREVIATIONS, AS WELL AS DIMENSIONING CONVENTIONS USED ON THIS SHEET.
- B. ALL DIMENSIONS SHOWN SHALL BE VERIFIED PRIOR TO CONSTRUCTION.
- C. REFER TO THE A3.X SERIES SHEETS FOR THE REFLECTED CEILING PLANS.
- D. REFER TO THE A9.2.X SERIES SHEETS FOR PARTITION SYSTEMS TYPES AND DETAILS.

WINDOW RESTORATION

- SEE DRAWINGS NOTES RELATED TO SPECIFIC REPAIRS AT EACH WINDOW. THE FOLLOWING NOTES APPLY TO ALL EXISTING WINDOWS WITHIN THE SANCTUARY AND BALCONY.
1. REMOVE LOOSE ENDS OF SASH CORDS. ALL WINDOWS ARE INOPERABLE AND SEALED SHUT. CHORDS ARE MISSING OR CUT AND DANGLING FROM JAMB PULLEYS. IT IS ASSUMED COUNTERWEIGHTS ARE STILL INTACT BEHIND THE JAMBS. REMOVE OLD/ UNUSED WINDOW TREATMENT BRACKETS AND HARDWARE.
 3. ADJUST EXISTING SASHES TO SECURELY FIT WITHIN EXISTING FRAMES WITHOUT GAPS.
 4. INSTALL WEATHERSTRIPPING BETWEEN SASHES AND FRAMES.
 5. CLEAN AND PREPARE (MINOR SCRAPING AND REMOVAL OF LOOSE PAINT) INTERIOR SURFACE FOR REPAINTING. REPAINT INTERIOR OF SASHES, FRAME, TRIM AND SILL. REMOVE REMAINING OVER PAINT ON INTERIOR AND EXTERIOR OF GLAZING.

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Church Rehabilitation

40125 Bond Street
Waterford, VA 20197

SMITHGROUP

ARCHITECTURE/ HISTORIC PRESERVATION
1700 New York Avenue, NW
Suite 100
Washington, DC 20004
202.842.2100

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1053 31st Street NW
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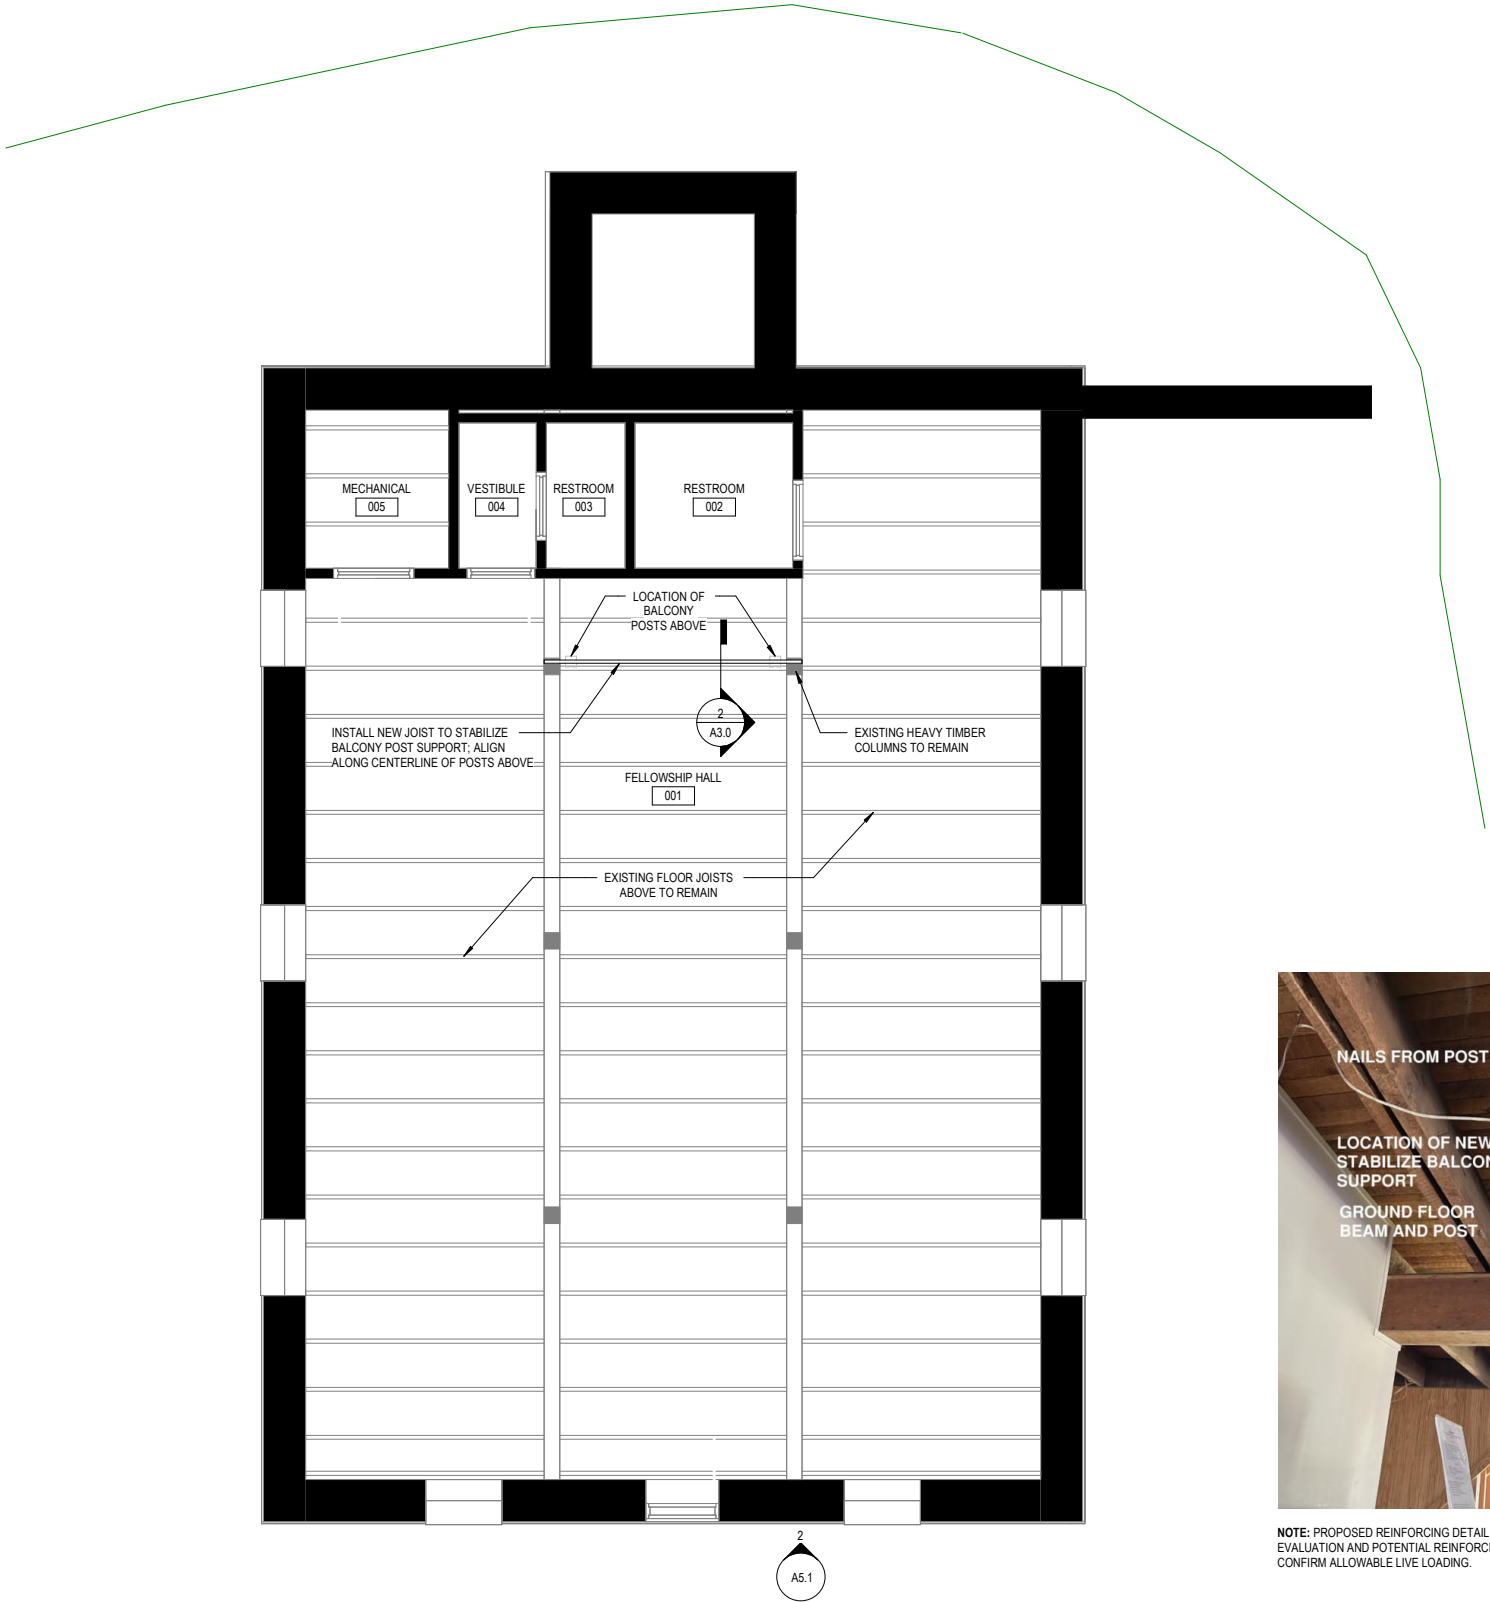
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SHEET TITLE
SANCTUARY FLOOR
PLAN

PROJECT NUMBER 15362.000
SHEET NUMBER A2.1



1 BASEMENT REFLECTED CEILING PLAN
SCALE: 1/4" = 1'-0"

2 STRUCTURAL REINFORCEMENT AT BALCONY POSTS
SCALE: NOT TO SCALE

GENERAL SHEET NOTES

- A. REFER TO THE A0.X SERIES SHEETS FOR ARCHITECTURAL GENERAL NOTES, DRAWING, REFERENCE AND MATERIAL SYMBOLS, ABBREVIATIONS, AS WELL AS DIMENSIONING CONVENTIONS USED ON THIS SHEET.
- B. VERTICAL ELEVATIONS ON THIS PLAN ARE SHOWN RELATIVE TO THE FINISH FLOOR DESIGN REFERENCE ELEVATION UNLESS OTHERWISE NOTED. REFER TO THE "REFERENCE ELEVATION DEFINITIONS" LOCATED IN THE A0.X SERIES SHEETS.
- C. REFER TO THE A0.X SERIES SHEETS FOR TYPICAL RULES AND REQUIREMENTS GOVERNING THE LOCATION OF CEILING ITEMS SHOWN BUT NOT DIMENSIONED ON THE REFLECTED CEILING PLANS.

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40125 Bond Street
Waterford, VA 20197

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ARCHITECTURE/ HISTORIC PRESERVATION
1700 New York Avenue, NW
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KEYPLAN

NORTH




SHEET TITLE

BASEMENT REFLECTED
CEILING PLAN

PROJECT NUMBER 15362.000

SHEET NUMBER

A3.0

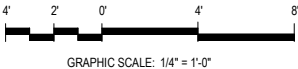

GRAPHIC SCALE: 1/4" = 1'-0"

A. REFER TO THE A0.X SERIES SHEETS FOR ARCHITECTURAL GENERAL NOTES, DRAWING, REFERENCE AND MATERIAL SYMBOLS, ABBREVIATIONS, AS WELL AS DIMENSIONING CONVENTIONS USED ON THIS SHEET.

B. VERTICAL ELEVATIONS ON THIS PLAN ARE SHOWN RELATIVE TO THE FINISH FLOOR DESIGN REFERENCE ELEVATION UNLESS OTHERWISE NOTED. REFER TO THE "REFERENCE ELEVATION DEFINITIONS" LOCATED IN THE A0.X SERIES SHEETS.

C. REFER TO THE A0.X SERIES SHEETS FOR TYPICAL RULES AND REQUIREMENTS GOVERNING THE LOCATION OF CEILING ITEMS SHOWN BUT NOT DIMENSIONED ON THE REFLECTED CEILING PLANS.

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Waterford, VA 20197

ARCHITECTURE/ HISTORIC PRESERVATION
1700 New York Avenue, NW
Suite 100
Washington, DC 20004
202.842.2100

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CONSTRUCTION

KEYPLAN



SHEET TITLE


SANCTUARY REFLECTED CEILING PLAN

PROJECT NUMBER 15362.000


15362.000 —

SHEET NUMBER

A3.1

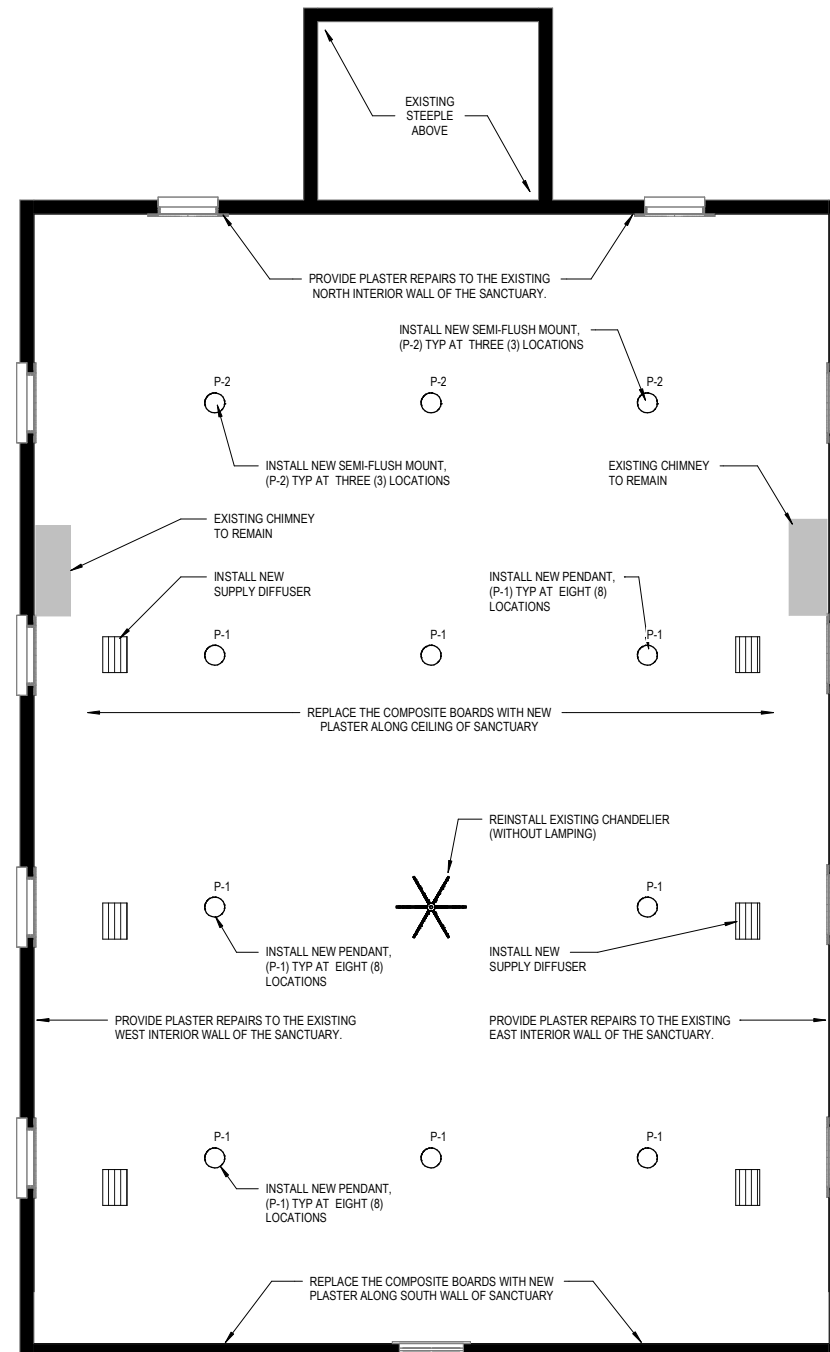

1 SANCTUARY REFLECTED CEILING PLAN
SCALE: 1/4" = 1'-0"

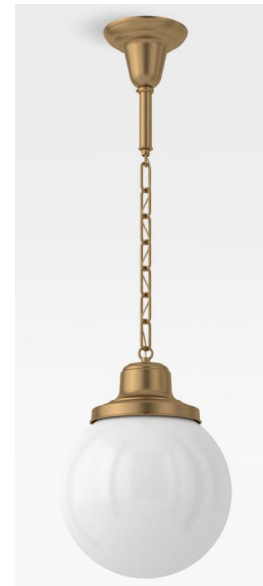

LIGHT FIXTURE TYPE P-1
BASIS OF DESIGN:
REJUVENATION LIGHTING
ROSE CITY 6 FITTER CHAIN PENDANT
FINISH: HERITAGE BRASS
GLOBE: 10" OPAL GLOBE SHADE



LIGHT FIXTURE TYPE P-2
BASIS OF DESIGN:
REJUVENATION LIGHTING
ROSE CITY 6 FITTER SEMI-FLUSH MOUNT
FINISH: HERITAGE BRASS
GLOBE: 10" OPAL GLOBE SHADE

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1700 New York Avenue, NW
Suite 100
Washington, DC 20004
202.842.2100

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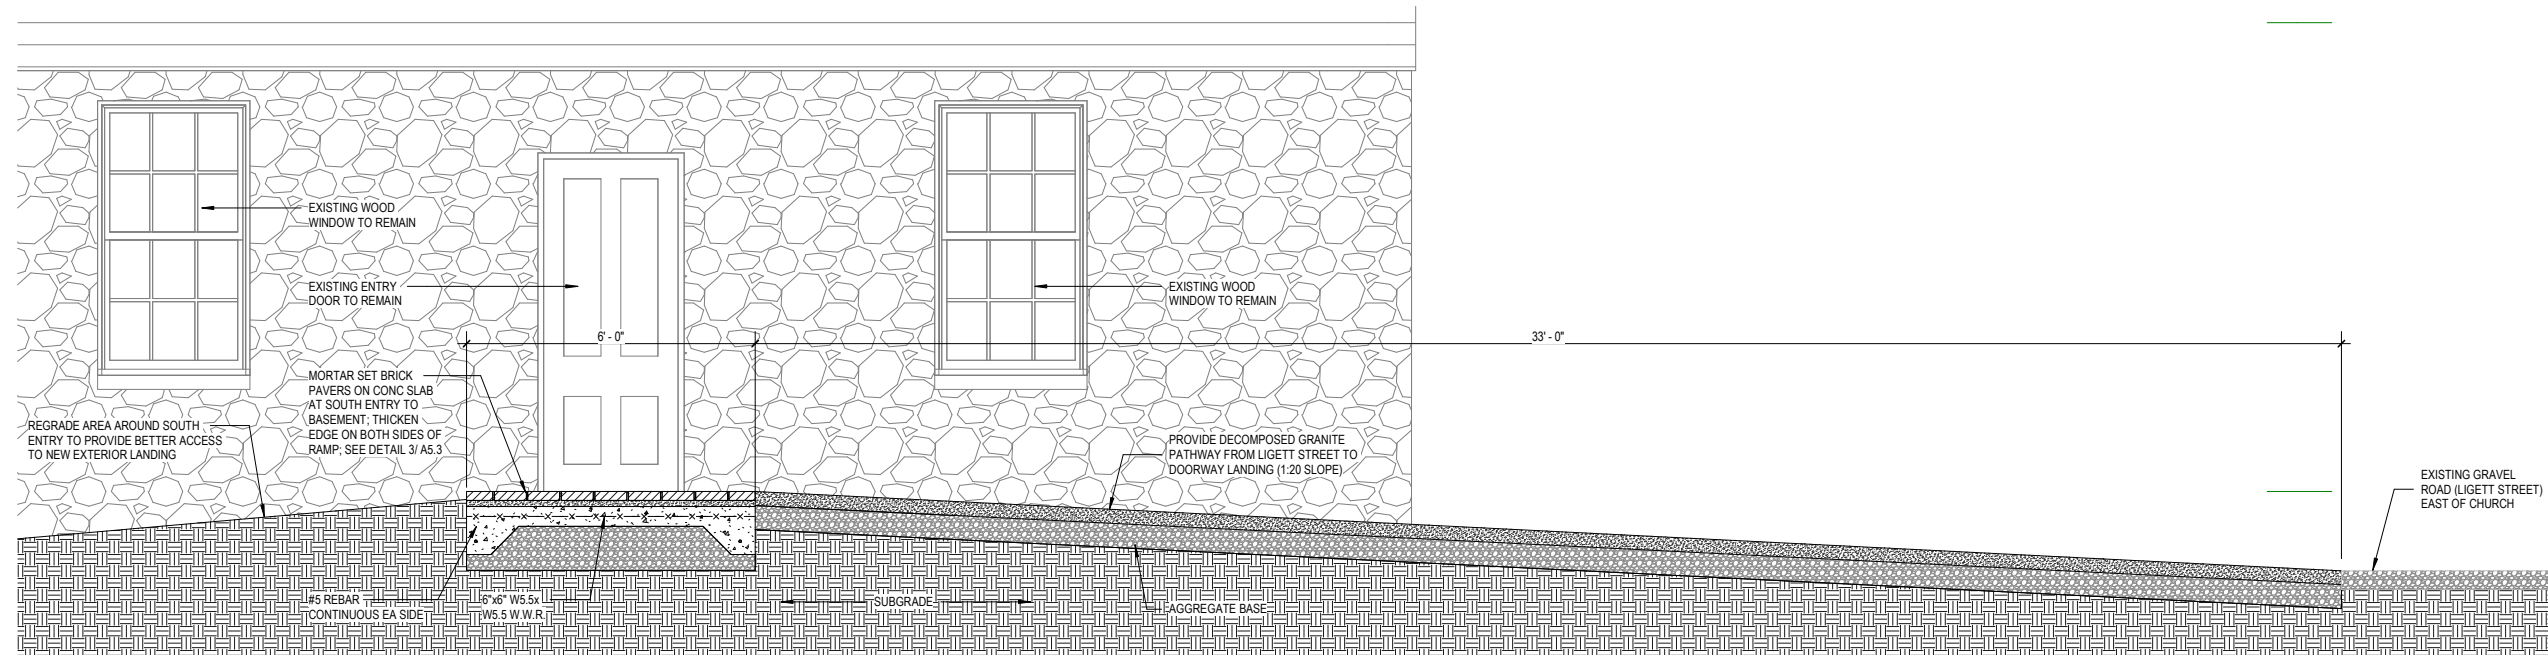
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BASEMENT ENTRY ENLARGED PLAN AND ELEVATION


PROJECT NUMBER 15362.000

A5.1

SHEET NUMBER



2 BASEMENT ENTRY SOUTH ELEVATION
SCALE: 1/2" = 1'-0"

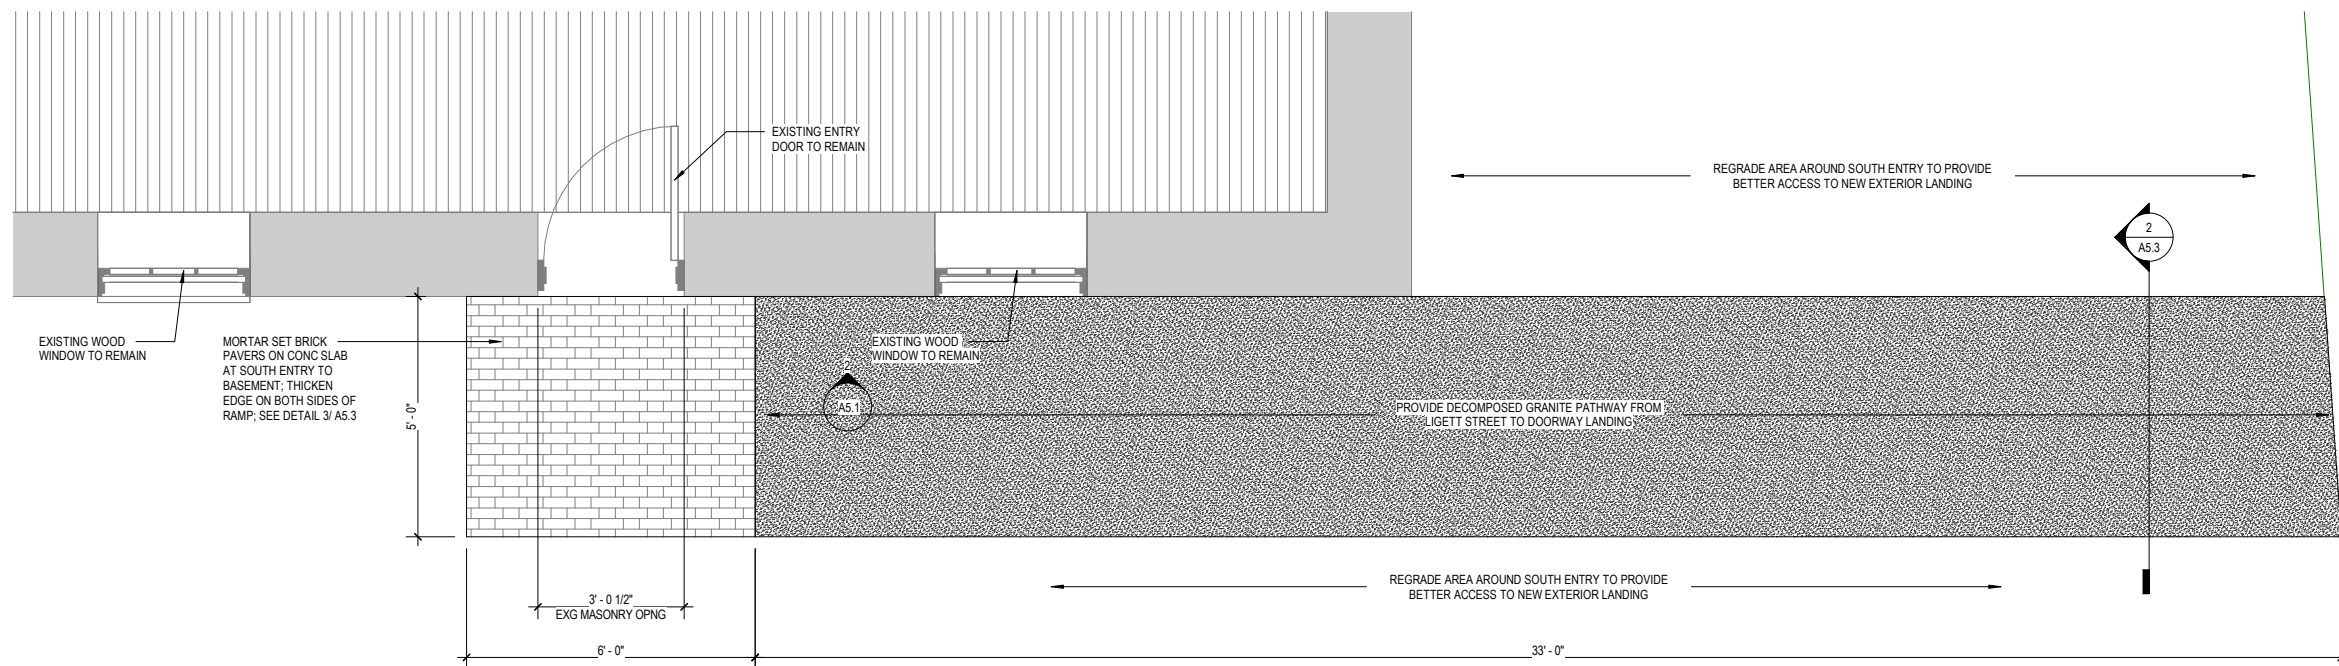

1 BASEMENT ENTRY ENLARGED PLAN
SCALE: 1/2" = 1'-0"

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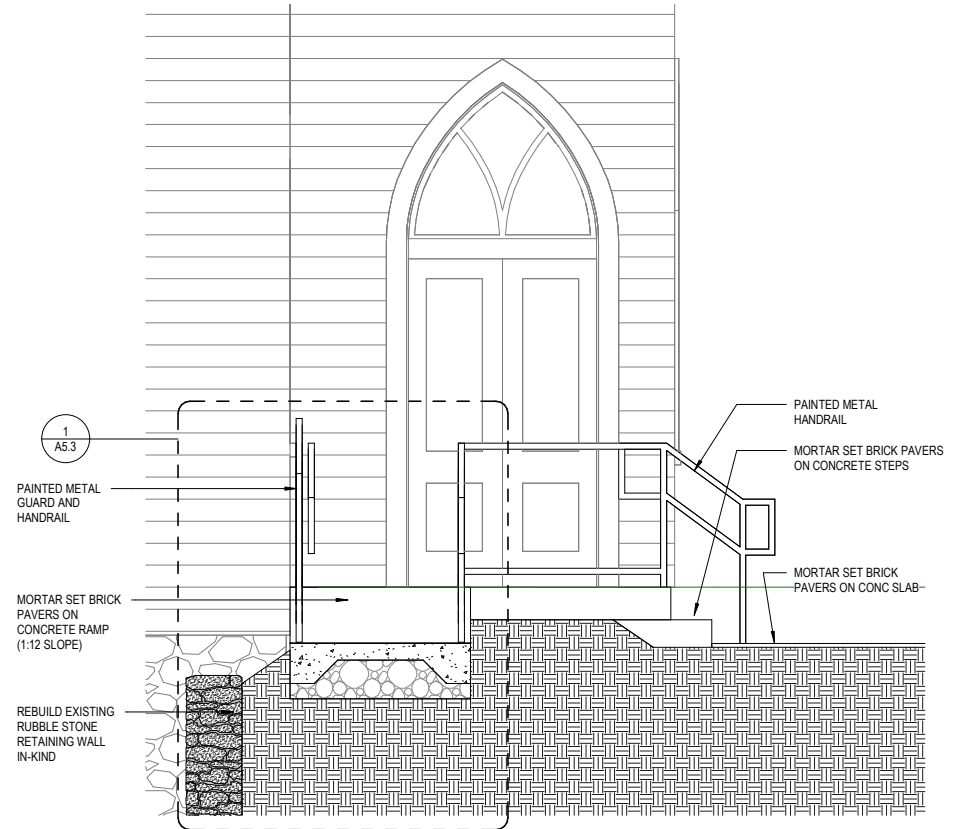
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FIRST FLOOR ENTRY ENLARGED PLAN AND ELEVATION

PROJECT NUMBER 15362.000


SHEET NUMBER

A5.2



2 SANCTUARY ENTRY NORTH ELEVATION
SCALE: 1/2" = 1'-0"

3 SANCTUARY ENTRY EAST ELEVATION
SCALE: 1/2" = 1'-0"

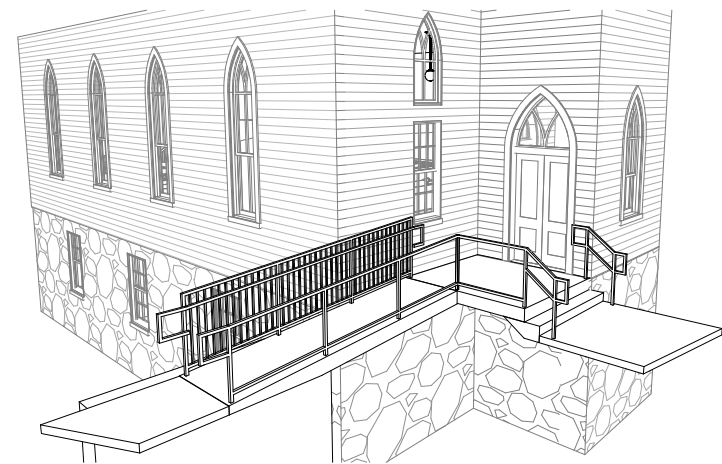

1 SANCTUARY ENTRY ENLARGED PLAN
SCALE: 1/2" = 1'-0"

4 NORTH ENTRY
SCALE:

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SHEET TITLE


EXTERIOR DETAILS

PROJECT NUMBER

362.000 —

A5.3

SHEET NUMBER

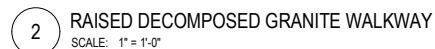

A. REFER TO THE A0.X SERIES SHEETS FOR ARCHITECTURAL GENERAL NOTES, DRAWING, REFERENCE AND MATERIAL SYMBOLS, ABBREVIATIONS, AS WELL AS DIMENSIONING CONVENTIONS USED ON THIS SHEET.

B. VERTICAL ELEVATIONS ON THIS PLAN ARE SHOWN RELATIVE TO THE FINISH FLOOR DESIGN REFERENCE ELEVATION UNLESS OTHERWISE NOTED. REFER TO THE "REFERENCE ELEVATION DEFINITIONS" LOCATED IN THE A0.X SERIES SHEETS.

C. REFER TO THE A0.X SERIES SHEETS FOR TYPICAL RULES AND REQUIREMENTS GOVERNING THE LOCATION OF CEILING ITEMS SHOWN BUT NOT DIMENSIONED ON THE REFLECTED CEILING PLANS.

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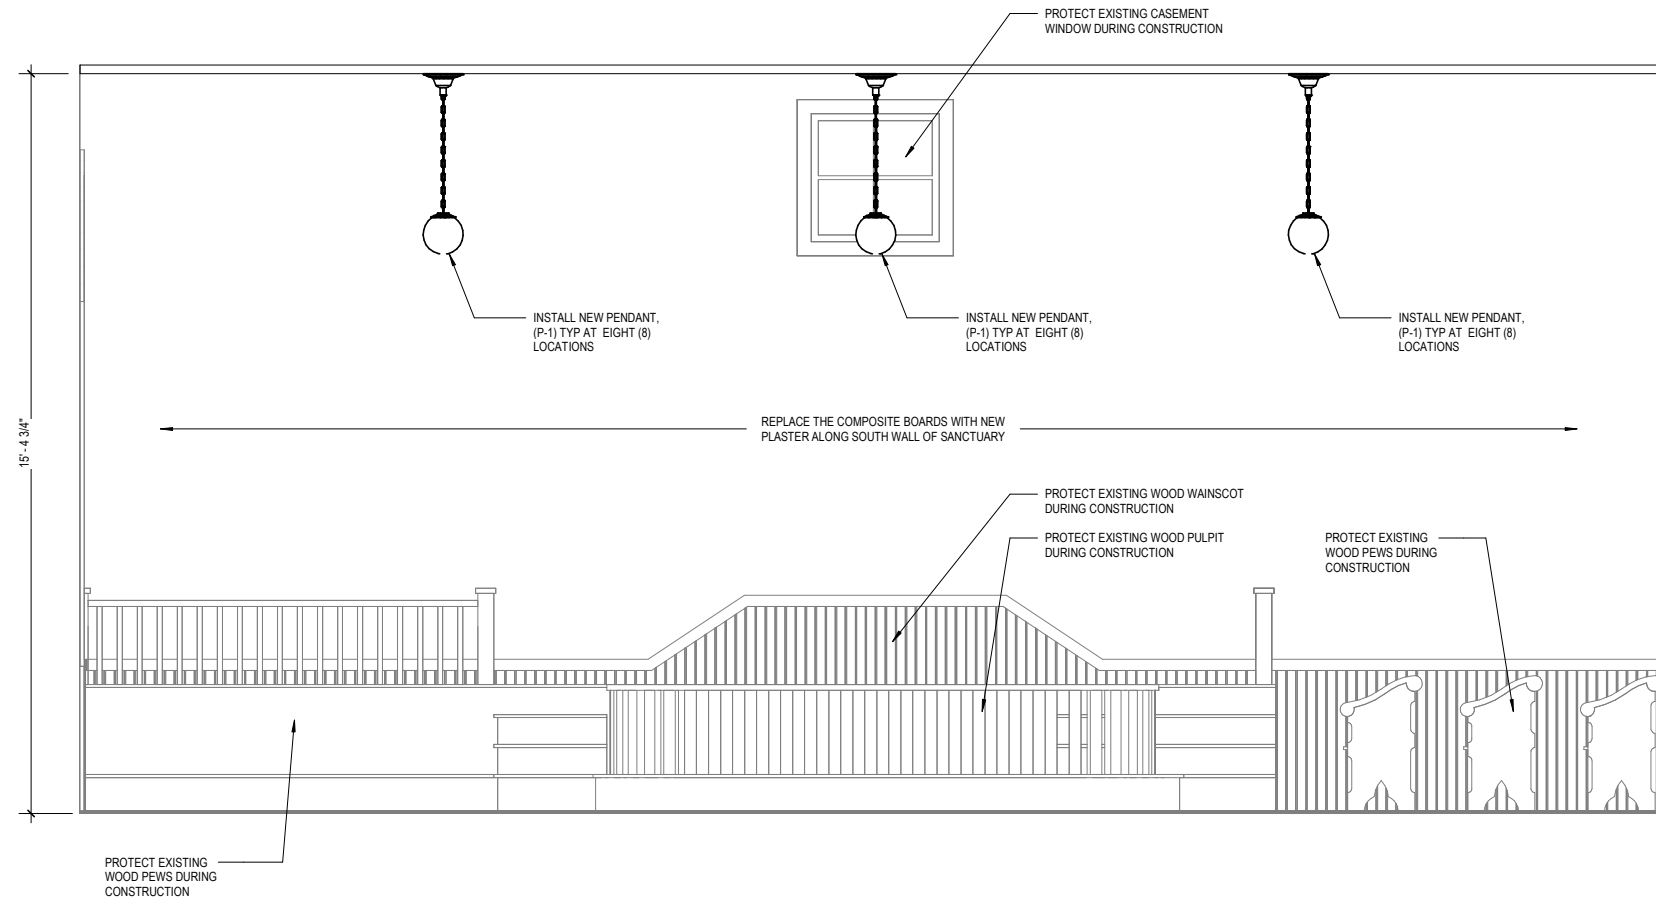
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SOUTH INTERIOR ELEVATIONS


PROJECT NUMBER 15362.000

A8.1

SHEET NUMBER



1 SOUTH INTERIOR ELEVATION
SCALE: 1/2" = 1'-0"

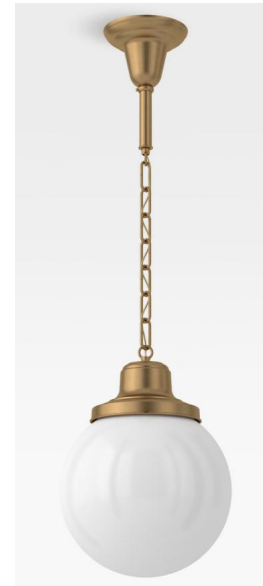

LIGHT FIXTURE TYPE P-1
BASIS OF DESIGN:
REJUVENATION LIGHTING
ROSE CITY 6 FITTER CHAIN PENDANT
FINISH: HERITAGE BRASS
GLOBE: 10" OPAL GLOBE SHADE



LIGHT FIXTURE TYPE P-2
BASIS OF DESIGN:
REJUVENATION LIGHTING
ROSE CITY 6 FITTER SEMI-FLUSH MOUNT
FINISH: HERITAGE BRASS
GLOBE: 10" OPAL GLOBE SHADE